City of Pittsburg Forward Together.

PUBLIC WORKS

201 W 4th Street Pittsburg, KS 66762 P: (620) 231-4100 www.pittks.org

Table of Contents

Agenda	3
Approval of Minutes	5
Consider approval of the December 20, 2021, Planning Commission/Board of	
Zoning Appeals meeting minutes.	
Case No. 22-01 – City of Pittsburg – Zoning Change – North Industrial Park	6
Consider a petition submitted by the City of Pittsburg to amend the Zoning	
Ordinance, changing certain areas from Not Zoned to IP-3: Planned Heavy	
Industrial. Application	c
Map	
Property Owner Listing	
Affidavit of Publication	
Task Report	
Case No. 22-02 – City of Pittsburg – Variance – 910 Memorial Drive	15
Consider a petition submitted by the City of Pittsburg for a variance at 910	
Memorial Drive to allow a communications tower.	
Application	15
Map	17
Development Plan	
Property Owner Listing	
Affidavit of Publication	
Task Report	54
Case No. 22-03 – Sullivan – Variance – 1515 E 14 th	55
Consider a petition submitted by Matthew Sullivan for a variance at 1515 E 14 th	
to allow a garage larger than 900 sq. ft.	
Application	55
Map	
Property Boundary Map	
Property Owner Listing	
Affidavit of Publication	
Task Report	60
Case No. 22-04 – Ribera – Conditional Use Permit – 205 W 20 th	61
Consider a petition submitted by Jose Ribera for a conditional use permit at	
205 W 20 th to allow for a church.	
Application	
Map	
Property Owner Listing	
Affidavit of Publication	67

Task Report	68
Case No. 21-25 – Horton's Pizza Plus – Site Plan – 1601 E 4 th	69
Consider the approval of a Site Plan submitted by Horton's Pizza Plus for	
property located at 1601 E 4 th .	
Application	69
Site Plan	72
Task Report	80

City of Pittsburg Forward Together.

PUBLIC WORKS

201 W 4th Street Pittsburg, KS 66762 P: (620) 231-4100 www.pittks.org

City of Pittsburg, Kansas Planning Commission/Board of Zoning Appeals

Municipal Court Room, Law Enforcement Center Monday, January 24, 2022 | 5:30 pm

- I. Call to Order
 - a. Flag Salute Led by Chairperson
- II. Election of Chairperson and Vice-Chairperson
 - a. Elect a new Chairperson
 - b. Elect a new Vice-Chairperson
- III. Consider the Following:
 - a. Approval of Minutes
 - i. Consider the approval of the December 20, 2021, Planning Commission/Board of Zoning Appeals meeting minutes.
 - 1. Motion, Second, and Vote
- IV. Public Hearings
 - a. Case No. 22-01 City of Pittsburg Zoning Change North Industrial Park: The City of Pittsburg advertised for a Public Hearing to be held on January 24, 2022, at the Planning Commission/Board of Zoning Appeals Meeting, commencing at 5:30 pm, to consider a petition submitted by the City of Pittsburg to amend the Zoning Ordinance, changing certain areas from Not Zoned to IP-3: Planned Heavy Industrial.
 - i. Public Hearing
 - 1. Open Public Hearing
 - 2. Call applicant to speak about the request
 - 3. Hear persons in favor of the request
 - 4. Hear persons opposed to the request
 - 5. Allow for rebuttal
 - 6. Close Public Hearing
 - ii. Discussion & Deliberation
 - iii. Motion, Second, & Vote
 - b. Case No. 22-02 City of Pittsburg Variance 910 Memorial Drive: The City of Pittsburg advertised for a Public Hearing to be held on January 24, 2022, at the Planning Commission/Board of Zoning Appeals meeting, commencing at 5:30 pm, to consider a petition submitted by the City of Pittsburg for a variance at 910 Memorial Drive.
 - i. Public hearing

- 1. Open Public Hearing
- 2. Call applicant to speak about the request
- 3. Hear persons in favor of the request
- 4. Hear persons opposed to the request
- 5. Allow for rebuttal
- 6. Close Public Hearing
- ii. Discussion & Deliberation
- iii. Motion, Second, & Vote
- c. Case No. 22-03 Sullivan Variance 1515 E 14th: The City of Pittsburg advertised for a Public Hearing to be held on January 24, 2022, at the Planning Commission/Board of Zoning Appeals Meeting, commencing at 5:30 pm, to consider a petition submitted by Matthew Sullivan for a variance at 1515 E 14th.
 - i. Public Hearing
 - 1. Open Public Hearing
 - 2. Call applicant to speak about the request
 - 3. Hear persons in favor of the request
 - 4. Hear persons opposed to the request
 - 5. Allow for rebuttal
 - 6. Close Public Hearing
 - ii. Discussion & Deliberation
 - iii. Motion, Second, & Vote
- d. Case No. 22-04 Ribera Conditional Use Permit 205 W 20th: The City of Pittsburg advertised for Public Hearing to be held on January 24, 2022, at the Planning Commission/Board of Zoning Appeals Meeting, commencing at 5:30 pm, to consider a petition submitted by Jose Ribera for a conditional use permit at 205 W 20th.
 - i. Public Hearing
 - 1. Open Public Hearing
 - 2. Call applicant to speak about the request
 - 3. Hear persons in favor of the request
 - 4. Hear persons opposed to the request
 - 5. Allow for rebuttal
 - 6. Close Public Hearing
 - ii. Discussion & Deliberation
 - iii. Motion, Second, & Vote
- V. Site Plans
 - a. Case No. 21-25 Horton's Pizza Plus Site Plan 1601 E 4^{th} : Consider the approval of a Site Plan submitted by Horton's Pizza Plus for property located at 1601 E 4^{th} .
 - i. Discussion & Deliberation
 - ii. Motion, Second, Vote
- VI. Adjournment



PUBLIC WORKS

201 W 4th Street Pittsburg, KS 66762 P: (620) 231-4100 www.pittks.org

City of Pittsburg, Kansas Planning Commission/Board of Zoning Appeals

Municipal Court Room, Law Enforcement Center December 20, 2021 | 5:30 pm

Members Present: City Staff: Martin Dickinson, Mike Hanika, Laura Klusener, Michael Wilber

DeAnna Goering, Quentin Holmes,

- I. Call to Order
 - a. Meeting called to order at 5:36 PM
 - b. Vice-Chairperson Dickinson led the flag salute
- II. Consider the Following:
 - a. Approval of Minutes
 - Consider the approval of the November Meeting Minutes (November 22, 2021)
 - 1. Motion: Approve November Minutes (Klusener)
 - a. Motion: Seconded (Wilber)
 - b. Motion: Carried, 4-0-0
- III. Public Hearings
 - a. Case No. 21-23 Cesar Segovia Site Plan 3014 N Broadway
 - On the motion of Wilber, seconded by Hanika, the Planning Commission/Board of Zoning Appeals approved the site plan submitted by Cesar Segovia for 3014 N Broadway.
 - 1. Motion Carried, 3-0-1 (Abstain: Dickinson)
 - b. Case No. 21-24 City of Pittsburg Variance 510 Deill
 - Following Public Hearing, on the motion of Wilber, seconded by Hanika, the Planning Commission/Board of Zoning Appeals approved the request submitted by the City of Pittsburg to consider a variance at 510 Deill.
- IV. Adjournment
 - a. Motion: Adjourn the regular meeting of the Planning Commission/Board of Zoning Appeals. (Klusener)
 - i. Motion: Seconded (Wilber)
 - ii. Motion: Carried, 4-0-0
 - b. Meeting adjourned at 05:54 pm

ATTEST:	Chairperson
DeAnna Goering, Secretary	



Return Completed Application to:

Zoning Administrator 201 W 4th Street Pittsburg, KS 66762 Date Filed: 12/10/2021
Date Paid: No Charge - City

Publication Date: 12/7/2021 PC/BZA Date: 1/23/2022

Zoning Change Application

Applicants	nformation			
Name: Ci	ty of Pittsburg			
Address: 20	ГW 4th, PO BOX	600, Pitsburg, 1	KS WETLOW	
	0-5651		ona.goering@pltt	cs.org
Property Ow	ner's Information	tour Broken Broken	3-1	
Name: Ci	ry of Pittsburg			
Address: 20	I'W 4th, PO BOX LESS	B, Pittsburg, KS (0107162	
	0-5551		nna. goening@pitks	s.ora
Property Inf	ormation		9 791	
Property Add	ess: 4303 N Free Vi	ng Hwy (019-202-	09-0-00-00-010	(0-00.0
Property's Cu	rrent Zone: NZ/Aq		Proposed Zone: 1P-	
Property's Cu	rrent Use:	ial Residential	☐ Industrial	☑ Vacant
Property's De	sired Use:	ial	📜 Industrial	□ Vacant
Use and Zonii	g of Adjacent Properties:	I		
	North	South	East	West
U	e: Vacant/Agricultur	i Industrial	Vacant/ rancultival	Vacant/Agricultival
U Zonir	117/	I (ndustrval IP-3	Vacant/ngricultizal NZ/Agricultural	0
Zonir	g: NZ/Agriwana	IP-3	NZ/Agricultural	NZ/Agricultural
Zonir	g: NZ/Agriwana		NZ/Agricultural	0
Zonir	g: NZ/Agriwana	IP-3	NZ/Agricultural	NZ/Agricultural
Zonir	g: NZ/Agriwana	IP-3	NZ/Agricultural	NZ/Agricultural
Zonir Reasons for Z	g: NZ/Agriwthval	IP-3	NZ/Agricultural	NZ/Agricultural
Zonir Reasons for Z	g: NZ/Agriwthval	IP-3 Strict puru addition	NZ/Agricultural	NZ/Agricultural
Zonir Reasons for Z	g: NZ/Agriwthval	IP-3 Strict puru addition	NZ/Agricultural	NZ/Agricultural
Zonir Reasons for Z	g: NZ/Agriwthval	IP-3 Strict puru addition	NZ/Agricultural	NZ/Agricultural
Zonir Reasons for Z	g: NZ/Agriwthval	IP-3 Strict puru addition	NZ/Agricultural	NZ/Agricultural


0	C- L'Castian	
()wner's	Certification	

I/we acknowledge the receipt of the instruction packet explaining the method of submitting this application. I/we realize that this application cannot be processed unless it is completed in its entirety, is accompanied by all required supporting documentation as required in the instruction packet, and is accompanied by the appropriate, non-refundable fee.

I/we further certify that the foregoing information is true and correct to the best of my/our knowledge. If my/our request is granted, I/we will complete construction in accordance with plans submitted and approved by the Planning Commission/Board of Zoning Appeals (PC/BZA).

I/we authorize unannounced inspections of the subject property by City staff for the purpose of collecting information to review and analyze this request. I/we acknowledge that the PC/BZA and the Governing Body of the City of Pittsburg, Kansas, shall have authority to impose such conditions as it deems necessary in order to serve the public interest and welfare.

Owner's Signature		Date
This application must bear the signature(s) of the owner's behalf, the agent shall sign his own nar application.	ne property owner me and attach the	(s). If an authorized agent signs on the Owner Authorization form to this
0	ffice Use Only	
Date Received: 12/10/2021	Date Reviewed:	1/23/2022
☐ Approved ☐ Denied		and the little
Conditions of Approval/Reasons for Denial		
- /		. *1 8 ./
Signature of Zoning Administrator		(seal)

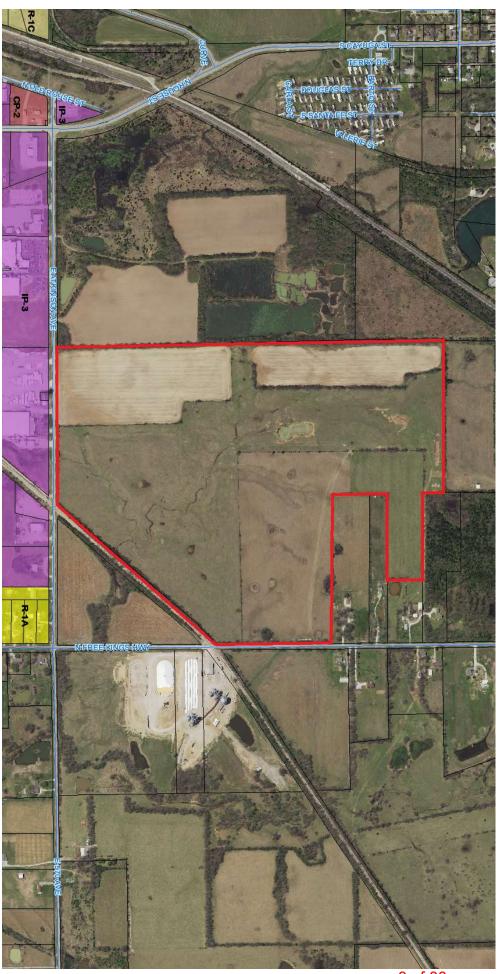

8 of 80

RECEIVED

Ownership List

DEC 07 2021

City of Pittsburg Community Development

PROPERTY TAX ID: 019-202-09-0-00-00-010.00-0

PROPERTY OWNER & ADDRESS:

4303 N. Free King Hwy Pittsburg, KS 66762

Subject Property:

The Surface only of the South Twenty-five (25) Acres of the Southwest Quarter (SW1/4) of the Northeast Quarter (NE/4) of Section Nine (9), Township Thirty (30) South, Range Twenty-five (25) East of the Sixth Principal Meridian, Crawford County, Kansas, according to the United States Government Survey thereof.

The North Half of the South Half of the Southeast Quarter (SE/4) of the Northeast Quarter (NE/4) of Section Nine (9), Township Thirty (30) South, Range Twenty-Five (25) East of the Sixth Principal Meridian, Crawford County, Kansas, according to the United States Government Survey thereof.

The surface only of the Southeast Quarter (SE/4) of Section Nine (9), Township Thirty (30) South, Range Twenty-Five (25) East of the Sixth Principal Meridian, Crawford County, Kansas, according to the United States Government Survey thereof,

EXCEPT

the North Five (5) Acres of the Northeast Quarter of the said Southeast Quarter of Section Nine (9) ALSO EXCEPT

the Right-of-Way of the Missouri Pacific Railroad Company, formerly the Nevada and Minden Railway Company, over and across said Real Estate.

ALSO EXCEPT

that part of the Southeast Quarter of the Southeast Quarter (SE/4 of SE/4) lying Southeast of the Missouri Pacific Railroad Company right-of-way (formerly known as the Southeast Kansas Railroad Company & the Nevada and Minden Railway Company), as now established, in Section Nine (9), Township Thirty (30) South, Range Twenty-Five (25) East, Crawford County, Kansas, being more particularly described as follows:

Commencing at a found aluminum monument marking the Southeast corner of the Southeast Quarter of said Section Nine (9); thence South 88 degrees 18 minutes 24 seconds West along the South line of said Southeast Quarter, a distance of 38.00 feet, to the point of intersection with the West right-of-way line of North Free King Highway as now established, said point also being the POINT OF BEGINNING; thence continuing South 88 degrees 18 minutes 24 seconds West, along said South line, a distance of 1,152.37 feet, to the point of intersection with the Southeast right-of-way line of Missouri Pacific Railroad Company right-of-way (formerly known as Southeast Kansas Railroad Company & the Nevada and Minden Railway Company), as now established; thence departing said South line, North 38 degrees 55 minutes 29 seconds East, along said Southeast right-of-way line, a distance of 1,441.87 feet to a point of curvature; thence in a Northeasterly direction, continuing along said Southeast right-of-way line, along a tangent curve to right, having a radius of 2,814.79 feet, through a central angle of 06 degrees 05 minutes 06 seconds East, an arc length of 298.94 feet to a point of non- tangency, said point also being on the West right-of-way line of said North free King Highway; thence departing said Southeast right-of-way line, South 02 degrees 01 minutes 03 seconds East, along said West right-of-way line, a distance of 1,310.66 feet to the point of beginning.

2020900000002010 2020902012001000 Nicholas Drew & Katelyn Ann Standlee 540 E. McKay St. Frontenac, KS 66763

2020900000007000 City of Frontenac PO Box 1012 Frontenac, KS 66763-1012

2020900000008000 Bill Muse Trust 4107 N. Free King Hwy Pittsburg, KS 66762-8415

2020900000009000 John Wayne Bough 4203 Free King Hwy Pittsburg, KS 66762-8414

2020900000010010 2021000000014000 2021000000017010 The Scoular Company 2027 Dodge St. Omaha NE 68102-1240

2020900000011000 2020900000012000 2051601002001000 City of Pittsburg Kansas PO Box 688 Pittsburg, KS 66762-0688

202100000012000 Stanley L. Forrest 4306 N. Free King Hwy Pittsburg, KS 66762-8413 202100000012020 Michael R. & Nancy S. Natalini Rev. Living Trust 4404 N. Free King Hwy Pittsburg, KS 66762-8561

2021000000012030 Daniel A. & Christina L. Smith 4112 N. Free King Hwy Pittsburg, KS 66762-8415

2021000000014010 Vanbecelaere Family Trust 4108 N. Free King Hwy Pittsburg, KS 66762-8415

2051601001003010 Kin Network Inc. C/O Duff & Phelps LLC PO Box 2629 Addison, TX 75001-2629

2051601001003020 Michael G. & Teri L. Blancho 707 N. Free King Hwy Pittsburg, KS 66762-8482

2051601002002000 Sanderson Pipe Corporation 875 International Blvd. Clarksville, TN 37040

2051602001001000 Pitt Plastics Inc. PO Box 405 Lolita, TX 77971-0405

We hereby certify the following to be a true and correct list of property owners within a 200 foot radius of:

The Surface only of the South Twenty-five (25) Acres of the Southwest Quarter (SW1/4) of the Northeast Quarter (NE/4) of Section Nine (9), Township Thirty (30) South, Range Twenty-five (25) East of the Sixth Principal Meridian, Crawford County, Kansas, according to the United States Government Survey thereof.

The North Half of the South Half of the Southeast Quarter (SE/4) of the Northeast Quarter (NE/4) of Section Nine (9), Township Thirty (30) South, Range Twenty-Five (25) East of the Sixth Principal Meridian, Crawford County, Kansas, according to the United States Government Survey thereof.

The surface only of the Southeast Quarter (SE/4) of Section Nine (9), Township Thirty (30) South, Range Twenty-Five (25) East of the Sixth Principal Meridian, Crawford County, Kansas, according to the United States Government Survey thereof,

EXCEPT

the North Five (5) Acres of the Northeast Quarter of the said Southeast Quarter of Section Nine (9) ALSO EXCEPT

the Right-of-Way of the Missouri Pacific Railroad Company, formerly the Nevada and Minden Railway Company, over and across said Real Estate.

ALSO EXCEPT

that part of the Southeast Quarter of the Southeast Quarter (SE/4 of SE/4) lying Southeast of the Missouri Pacific Railroad Company right-of-way (formerly known as the Southeast Kansas Railroad Company & the Nevada and Minden Railway Company), as now established, in Section Nine (9), Township Thirty (30) South, Range Twenty-Five (25) East, Crawford County, Kansas, being more particularly described as follows:

Commencing at a found aluminum monument marking the Southeast corner of the Southeast Quarter of said Section Nine (9); thence South 88 degrees 18 minutes 24 seconds West along the South line of said Southeast Quarter, a distance of 38.00 feet, to the point of intersection with the West right-of-way line of North Free King Highway as now established, said point also being the POINT OF BEGINNING; thence continuing South 88 degrees 18 minutes 24 seconds West, along said South line, a distance of 1,152.37 feet, to the point of intersection with the Southeast right-of-way line of Missouri Pacific Railroad Company right-of-way (formerly known as Southeast Kansas Railroad Company & the Nevada and Minden Railway Company), as now established; thence departing said South line, North 38 degrees 55 minutes 29 seconds East, along said Southeast right-of-way line, a distance of 1,441.87 feet to a point of curvature; thence in a Northeasterly direction, continuing along said Southeast right-of-way line, along a tangent curve to right, having a radius of 2,814.79 feet, through a central angle of 06 degrees 05 minutes 06 seconds East, an arc length of 298.94 feet to a point of non- tangency, said point also being on the West right-of-way line of said North free King Highway; thence departing said Southeast right-of-way line, South 02 degrees 01 minutes 03 seconds East, along said West right-of-way line, a distance of 1,310.66 feet to the point of beginning.

RECEIVED

DEC 07 2021

City of Pittsburg Community Development

Security 1st Title LLC

Debra L. Engstrom, Licensed Abstractor

File No. 2492031

22-01: Zoning Change North Undustrial Park

AFFIDAVIT OF PUBLICATION

STATE OF KANSAS, COUNTY OF CRAWFORD, SS:

Larry Hiatt, of lawful age, being first duly sworn, deposeth and saith, he/she is Legal Representative of the Pittsburg Morning Sun.

A daily newspaper published in the City of Pittsburg, Crawford County, Kansas, and not trade, religious, or fraternal publication, and which newspaper has been entered as second-class mail matter in the United States The Pittsburg Post Office, Pittsburg, Kansas. Morning Sun has been continuously uninterruptedly published daily for more and has been so than fifty weeks a year published for more than one year prior to the first publication of the notice hereinafter mentioned. A copy of that notice, is hereto attached, and was published in the regular and entire edition December 7, 2021 issue of said Pittsburg Morning Sun. Affiant further says that he has personal knowledge of the statements above set forth, and that they are true.

December 13, 2021

Notary Public

My Commission Expires:

Printer's Fee:

Kelly Mitchell
Notary Public
State of Kansas
My Appt Exp

RECEIVED

DEC 2 0 2021

City of Pittsburg Community Development

(Published in The Pittsburg Morning Sun on Tuesday, December 7, 2021) PUBLIC NOTICE

Planning Commission/Board of Zoning Appeals

Notice of Public Hearing

The Planning Commission/Board of Zoning Appeals of the City of Pittsburg, KS, will hold a Public Hearing on December 20, 2021 at 5:30 pm, in the Municipal Court Room of the Law Enforcement Center, 201 N Pine, to consider amending the Zoning Ordinance, changing certain areas from Not Zoned to IP-3: Planned Heavy Industrial. The property is described as:

A parcel of land located in the East half of Section 9, Township 30 South, Range 25 East of the 6th Principal Meridian, Crawford County, Kansas, more particularly described as follows:

Beginning at the Southwest corner of the Southeast Quarter of said Section, thence N03°12'44"W along the West line of said Quarter a distance of 2669.15 feet to the Northwest corner of said Quarter; thence N01°35'42"W along the West line of the Northeast Quarter of said Section a distance of 855.19 feet to the Southwest corner of a parcel described in Deed Book 641, Page 126 recorded in the Crawford County, Register of Deeds Office; thence N88°35'16"E along the South line of said parcel a distance of 1358.82 feet to the Southeast corner of said parcel, point also being on the West line of the Southeast Quarter of the Northeast Quarter; thence S02°01'21"E along said West line a distance of 183.31 feet to the Northwest corner of the South Half of the Southeast Quarter of the Northeast Quarter; thence N88°30'08"E along the North line of the South Half of the Southeast Quarter of the Northeast Quarter a distance of 768.06 feet; thence S00°51'46"E a distance of 333.09 feet; thence S88°27'30"W a distance of 760.91 feet to the West line of the Southeast Quarter of the Northeast Quarter; thence S02°05'27"E along said West line a distance of 333.67 feet to the Southwest corner of the Southeast Quarter of the Northeast Quarter; thence S02°36'49"E along the West line of the Northeast Quarter of the Southeast Quarter a distance of 166.66 feet; thence N88°24'26"E a distance of 1364.07 feet to the East line of the Southeast Quarter; thence S02°01'02"E along said East line a distance of 1018.83 feet to the Northwest Right-of-Way line of the Missouri Pacific Railroad Company; thence along said Right-of-Way line on a non-tangent curve to the left having a radius of 2914.79 feet, an arc length of 451.50 feet, a chord length of 451.05 feet and a chord bearing of S43°21'44"W; thence continuing along said Right-of-Way line S38°55'29"W a distance of 1527.65 feet to the South line of said Quarter; thence S88°18'18"W along said South line a distance of 1353.93 feet to the Point of Beginning. Said parcel contains 169.68 acres, more or less, and is subject to easements, reservations and restrictions of record. Legal Description prepared by Thad C. Reynolds, L.S.#1354, on November 16, 2021. Dated this December 2, 2021.

Planning Commission/Board of Zoning Appeals **ATTEST**:

Dexter Neisler


Zoning Administrator

Citizens with disabilities needing accommodations in order to attend this Public Hearing should contact the City Zoning Administrator's Office at §20f280-5517 no later than 48 hours prior to the scheduled public hearing.

Tasks Report

22-01: Zoning Change - North Industrial Park — City of Pittsburg

Generated: 20 Jan 2022 09:11

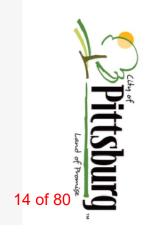

P&Z Administrative Tasks

Active Tasks

Upload Approved Minutes	Send Applicant Letter	Prepare City Commission Agenda Item	Task
			Start Date
			Due Date
DeAnna G.	DeAnna G.	DeAnna G.	Responsible Created
DeAnna G.	DeAnna G.	DeAnna G.	Created By
			Priority
0%	0%	0%	Progress Status
(Not started)	(Not started)	(Not started)	Status

Completed Tasks

Distribute Packets	Assigned Meeting Date	Notice to Utility Companies	Notice to Property Owners	Newspaper Publication	Completed Application Received	Task
						Start Date
						Due Date
DeAnna G.	Responsible					
DeAnna G.	Created By					
						Priority
100%	100%	100%	100%	100%	100%	Progress
Completed 01/20/2022 by DeAnna G.	Completed 12/02/2021 by DeAnna G.	Completed 12/07/2021 by DeAnna G.	Completed 12/07/2021 by DeAnna G.	Completed 12/02/2021 by DeAnna G.	Completed 12/02/2021 by DeAnna G.	Status

Generated for DeAnna Goering at 09:11 01/20/2022



Return Completed Application to:

Zoning Administrator 201 W 4th Street Pittsburg, KS 66762 PC/BZA Date: 124/2622

Variance Application

Applicant's Information
Name: City of Pittsburg
Address: 201 W 4th, PO BOX 688, Pittsburg, KS 66762
Phone: 620-231-4100 Email: jay.bylus@pi#ks.org
Property Information
Address of Affected Property: 910 Mumorial Drive
Applicant's Interest in Property:
Nature of Requested Variance: Lincoln Park Communications Tower
Legal Description of Property: 519, T30, R25, BOYES: 139.7, N 1/2 lug E HWy 169, W of
Olive Str, S of 20th Str, N of 12th Str 3 NW of Memorial Drine, also PT YER
15th Str, PT VAC Olive Str; AISO PT LOTS 6-8, BIOCK 12, K3T COOL CO'S 4th Add
Attach a sketch of the proposed variance.

Sie attached.

Owner's Certification

I/we acknowledge the receipt of the instruction packet explaining the method of submitting this application. I/we realize that this application cannot be processed unless it is completed in its entirety, is accompanied by all required supporting documentation as required in the instruction packet, and is accompanied by the appropriate, non-refundable fee.

I/we further certify that the foregoing information is true and correct to the best of my/our knowledge. If my/our request is granted, I/we will complete construction in accordance with plans submitted and approved by the Planning Commission/Board of Zoning Appeals (PC/BZA).

I/we authorize unannounced inspections of the subject property by City staff for the purpose of collecting information to review and analyze this request. I/we acknowledge that the PC/BZA and the Governing Body of the City of Pittsburg, Kansas, shall have authority to impose such conditions as it deems necessary in order to serve the public interest and welfare.

Recoma youring you Jay 48	yero 12/15/2021
Owner's Signature $\int V \int V$	Date
Owner's Signature	Date
	f the property owner(s). If an authorized agent signs on the name and attach the Owner Authorization form to this
	Office Use Only
Date Received: 12/15/21	Date Reviewed:
☐ Approved ☐ Denied	
Conditions of Approval/Reasons for Denial	
Signature of Zoning Administrator	(seal)




17 of 80

STATE LOCATION





SITE **LOCATION**

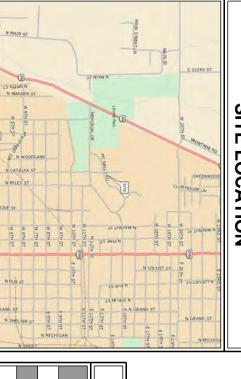

DRIVING DIRECTIONS

FROM SPRINGFIELD—BRANSON NATIONAL AIRPORT: TAKE PREFERRED ROUTE TO MO-266 W. TURN LEFT ONTO N STATE HWY B. TURN RIGHT ONTO I-44 W TOWARDS JOPLIN. MERGE ONTO I-44. TAKE EXIT 57 FOR MO-96 TURN RIGHT ONTO CO RD 80. TURN LEFT ONTO BASE LINE BLVD. TURN RIGHT ONTO MO-171 N. CONTINUE ONTO KS-171 W. TURN RIGHT ONTO US-160 E/US-69 N. TURN RIGHT ONTO 12TH ST. TURN LEFT ONTO MCNALLY RD. TURN LEFT. SITE WILL BE DIRECTLY ALFAN

PROJECT TEAM

PROJECT CONTACT:

ADDRESS CITY, STATE, CONTACT US CELLULAR CORPORATION 800 CORNERSTONE DRIVE KNOXVILLE, TN 37932 KEN HARDIN (865) 777-8054

TOWER OWNER:

ADDRESS CITY, STATE, ZIP CONTACT PHONE CIVIL ENGINEER: US CELLULAR CORPORATION 800 CORNERSTONE DRIVE KNOXVILLE, TN 37932 KEN HARDIN (865) 777–8054

ADDRESS CITY, STATE, ZIP CONTACT PHONE TOWER ENGINEERING PROFESSIONALS, INC. 326 TRYON ROAD RALEIGH, NC 27603-3530 JEREMY K. WOOSTER, P.E. (919) 661-6351

ELECTRICAL ENGINEER:

326 TRYON ROAD
RALEIGH, NC 27603-3530
JEREMY K. WOOSTER, P.E.
(919) 661-6351 ENGINEERING PROFESSIONALS, INC.

Z-1

PROJECT NOTES

PROPOSED 120-FT MONOPOLE **124-FT OVERALL HEIGHT)**

SITE NAME

_INCOLN PARK

SITE NUMBER

589403

SITE ADDRESS (E911 ADDRESS TBD)

CRAWFORD COUNTY PITTSBURG, KS 66762 MCNALLY ROAD

INDEX OF SHEETS

NO.	SHEET TITLE	REV
T-1	TITLE SHEET	2
1	SITE SURVEY	ı
C-1	SITE PLAN	2
C-2	COMPOUND DETAIL	2
C-3	TOWER ELEVATION	2
C-4AB	CABINET DETAILS	2
C-5	ICE BRIDGE DETAILS	2
C-6	COMPOUND FENCE DETAILS	2
C-7	SIGNAGE DETAILS	2
C-8A	SOIL & EROSION CONTROL PLAN	2
C-8B	SILT FENCE DETAILS	2
6-0	ACCESS ROAD DETAILS	2
C-10AB	ANTENNA MOUNTING DETAILS & SPECIFICATIONS	2
C-11A	RRH MOUNTING DETAILS	2
C-11B	RRH DETAILS	2
C-12AB	LTE PLUMBING DIAGRAMS	2
C-13AB	LABELING STANDARDS I & II	2
C-14	EQUIPMENT CANOPY ELEVATION & DETAILS	2
E-1	ELECTRICAL NOTES	2
E-2	ONE-LINE DIAGRAM & POWER PANEL SCHEDULE	2
E-3	POWER/TELCO PLAN	2
E-3A	EQUIPMENT H-FRAME & SERVICE RACK DETAILS	2
E-4	COMPOUND GROUNDING PLAN	2
E-5	EQUIPMENT GROUNDING PLAN	2
E-6,7,8	GROUNDING DETAILS I-III	2
)

PROJECT INFORMATION

PLANS PREPARED FOR:

%uscellular

800 CORNERSTONE DRIVE KNOXVILLE, TN 37932 (865) 777-8054

LATITUDE:

LONGITUDE:
EXISTING GROUND ELEVATION:
PROPOSED GROUND ELEVATION: N 37° 25' 12.22" * (NAD '83) W 94° 42' 46.51" * (NAD '83) 912.7' ± * (NAVD '88) N: 913.0' ± (NAVD '88)

SURVEYING, DATED 05/04/21. INFORMATION PER SURVEY PROVIDED BY HUSKER

PROJECT INFORMATION:

SITE #: 589403 LINCOLN PARK

MCNALLY ROAD
(E911 ADDRESS T.B.D.)
PITTSBURG, KS 66762
(CRAWFORD COUNTY)

ACCESS ISSUES: LOADING TYPE: N/A 4T4R/2T2R 120' MONOPOLE (124' OVERALL)

TOWER TYPE:

STRUCTURAL NOTE **GATE COMBO:**

PLANS PREPARED BY:

STRUCTURAL STATUS:

• MOUNT SA - N/A

• TOWER SA - N/A

SCOPE OF WORK

FOWER SCOPE:

- PROPOSED EQUIPMENT:

 (5) DENGYO OCT8-2LX2HX-BW65 ANTENNAS

 (3) SECTOR FRAMES (SABRE P/N: C10857777CDP OR APPROVED EQ.)

 (2) COLLAR MOUNTS (SABRE P/N: C10857801DP OR APPROVED EQ.)

 (2) QUAD BRACKET MOUNTS (SITE PRO P/N: UGLM4 OR APPROVED EQ.)

 (6) DUAL MOUNTS (SITE PRO P/N: CWT8 OR APPROVED EQ.)
- 1¼" HYBRID CABLE RAYCAP RUSDC-6267-PF-48

TOWER ENGINEERING PROFESSIONALS

326 TRYON ROAD RALEIGH, NC 27603-3530

OFFICE: (919) 661-6351 www.tepgroup.net

- NOKIA AHLOA RRHS NOKIA AHCA RRHS NOKIA AHFIB RRHS
- (2) NOKIA AHCA RRHS(3) NOKIA AHFIB RRHS(5) GROUND BARS (TOWER TOP, TOWER MIDDLE, AND BASE OF TOWER)

SEAL:

- LTE JUMPERS:

 (3) POWER JUMPERS FROM RAYCAP TO BAND 2/4 RRHS
 (3) POWER JUMPERS FROM RAYCAP TO BAND 2/4 RRHS
 (3) POWER JUMPERS FROM RAYCAP TO BAND 5 RRHS
 (6) FIBER JUMPERS FROM RAYCAP TO BAND 71/12 RRHS
 (6) FIBER POWER JUMPERS FROM RAYCAP TO BAND 2/4 RRHS
 (6) FIBER JUMPERS FROM RAYCAP TO BAND 5 RRHS
 (12) PROPOSED ½" JUMPERS FROM BAND 71/12 RRHS TO ANTENNA
 (12) PROPOSED ½" JUMPERS FROM BAND 2/4 RRHS TO ANTENNA
 (8) PROPOSED ½" JUMPERS FROM BAND 5 RRHS TO ANTENNA
 (3) RET JUMPERS FROM BAND 71/12 RRHS TO ANTENNA
 (2) RET JUMPERS FROM BAND 5 RRHS TO ANTENNA
 (2) RET JUMPERS FROM BAND 5 RRHS TO ANTENNA

GROUND EQUIPMENT SCOPE:

TANSAS META

CONAL ENGRAPHIAN MANAGEMENT

- CHARLES EQUIPMENT CABINETS

 10'x12' CONCRETE PAD

 ICE BRIDGE (19'-0" IN LENGTH REQUIRED)

 10'x12' EQUIPMENT CANOPY (SITEPRO P/N:

 RAYCAP RUSDG-6267-PF-48 (MOUNTED (N:COV1012-B)
 ON H-FRAME)
- JUNCTION BOX
- GROUND BARS CAC EQUIPMENT CABINET
- TELCO BOX
- (1) 200A POWER METER
 (1) MULTI-GANG METER SERVICE RACK WITH TELCO BOX
 (COORDINATE WITH LOCAL UTILITY COMPANY)
 (4) 6' UNISTRUTS FOR H-FRAME AND U-BOLTS FOR MOUNTING

R TO CONSTRUCTION.

SPECIAL REQUIREMENTS:

ANTENNA AZIMUTHS:
CONTRACTOR SHALL VERIFY AZIMUTHS PRIOR CONTRACTOR TO REQUEST RF SHEET FROM C DRAWNIGS.

CDL ELECTRIC CUSTOMER SERVICE (800) 392-4942 40 470 965

POWER COMPANY: CONTACT:

UTILITIES:

PHONE:
PEDESTAL # NEAR

SITE:

(800) 288—2020 JNKNOWN

FIBER COMPANY: CONTACT: METER # ON SITE:

AT&T CUSTOMER SERVICE Know what's below. Call before you dig.

TITLE SHEET

SHEET TITLE:

DRAWN BY:

CHECKED BY:


05-17-21 08-10-21 10-15-21


PRELIMINARY

DATE


SSUED PRELIMINARY FOR:


SHEET NUMBER REVISION

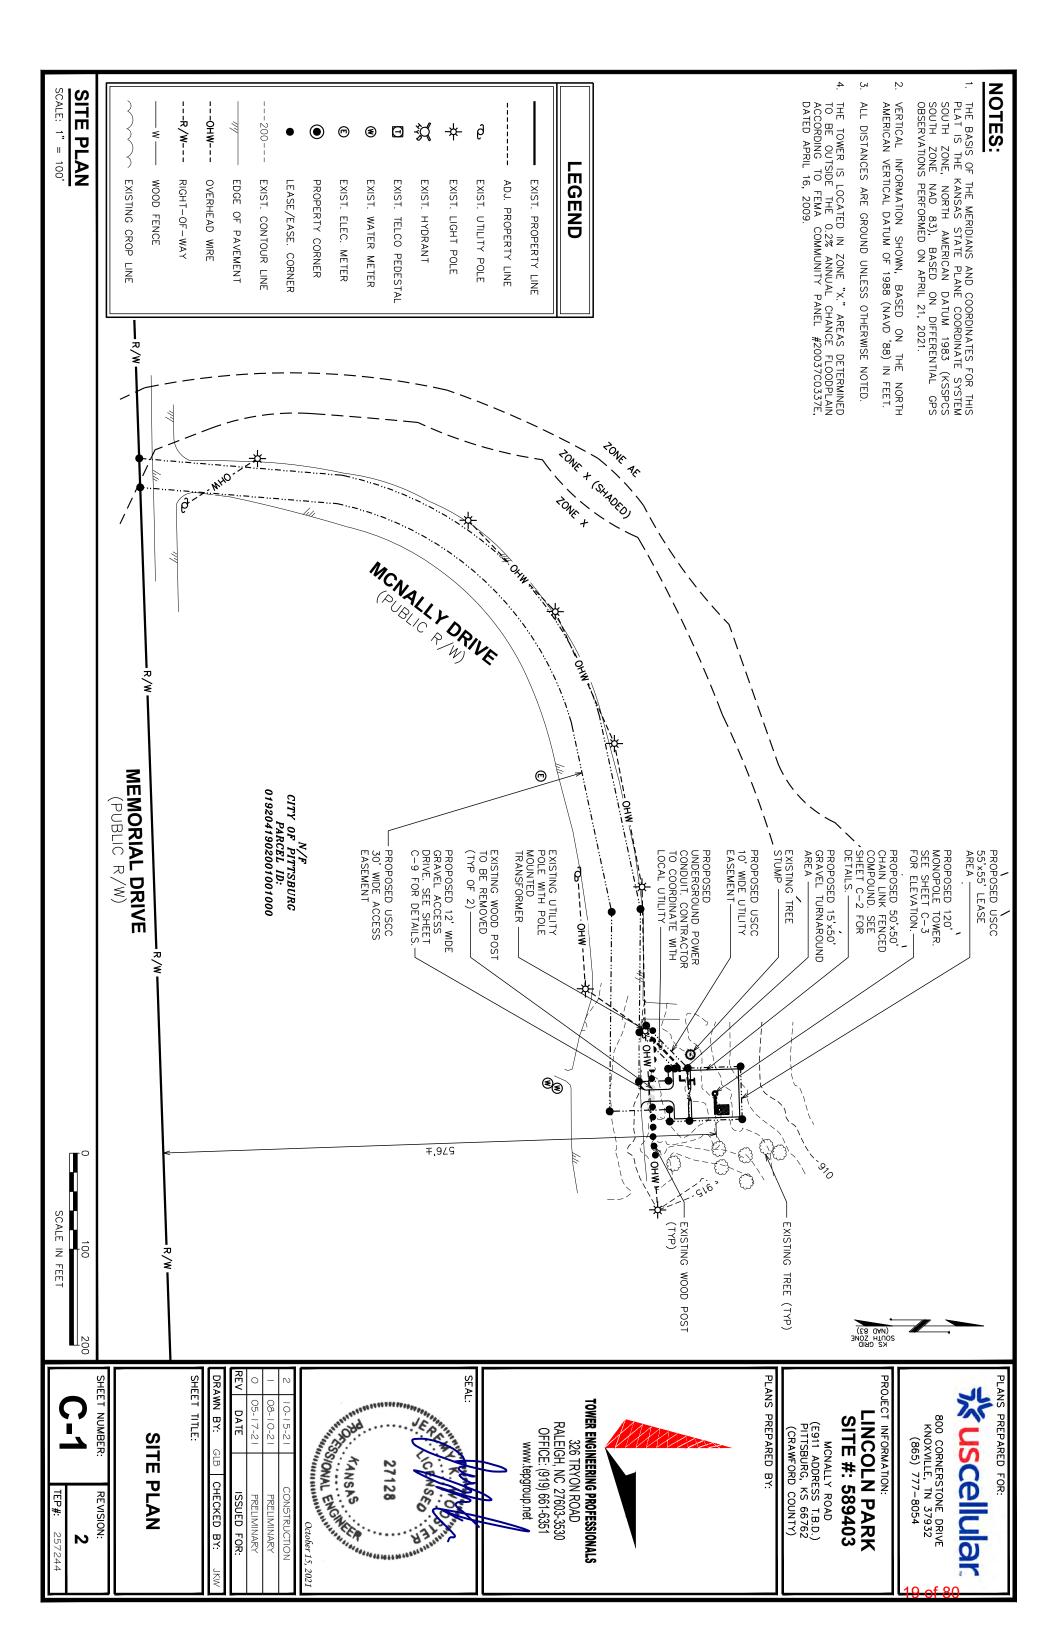

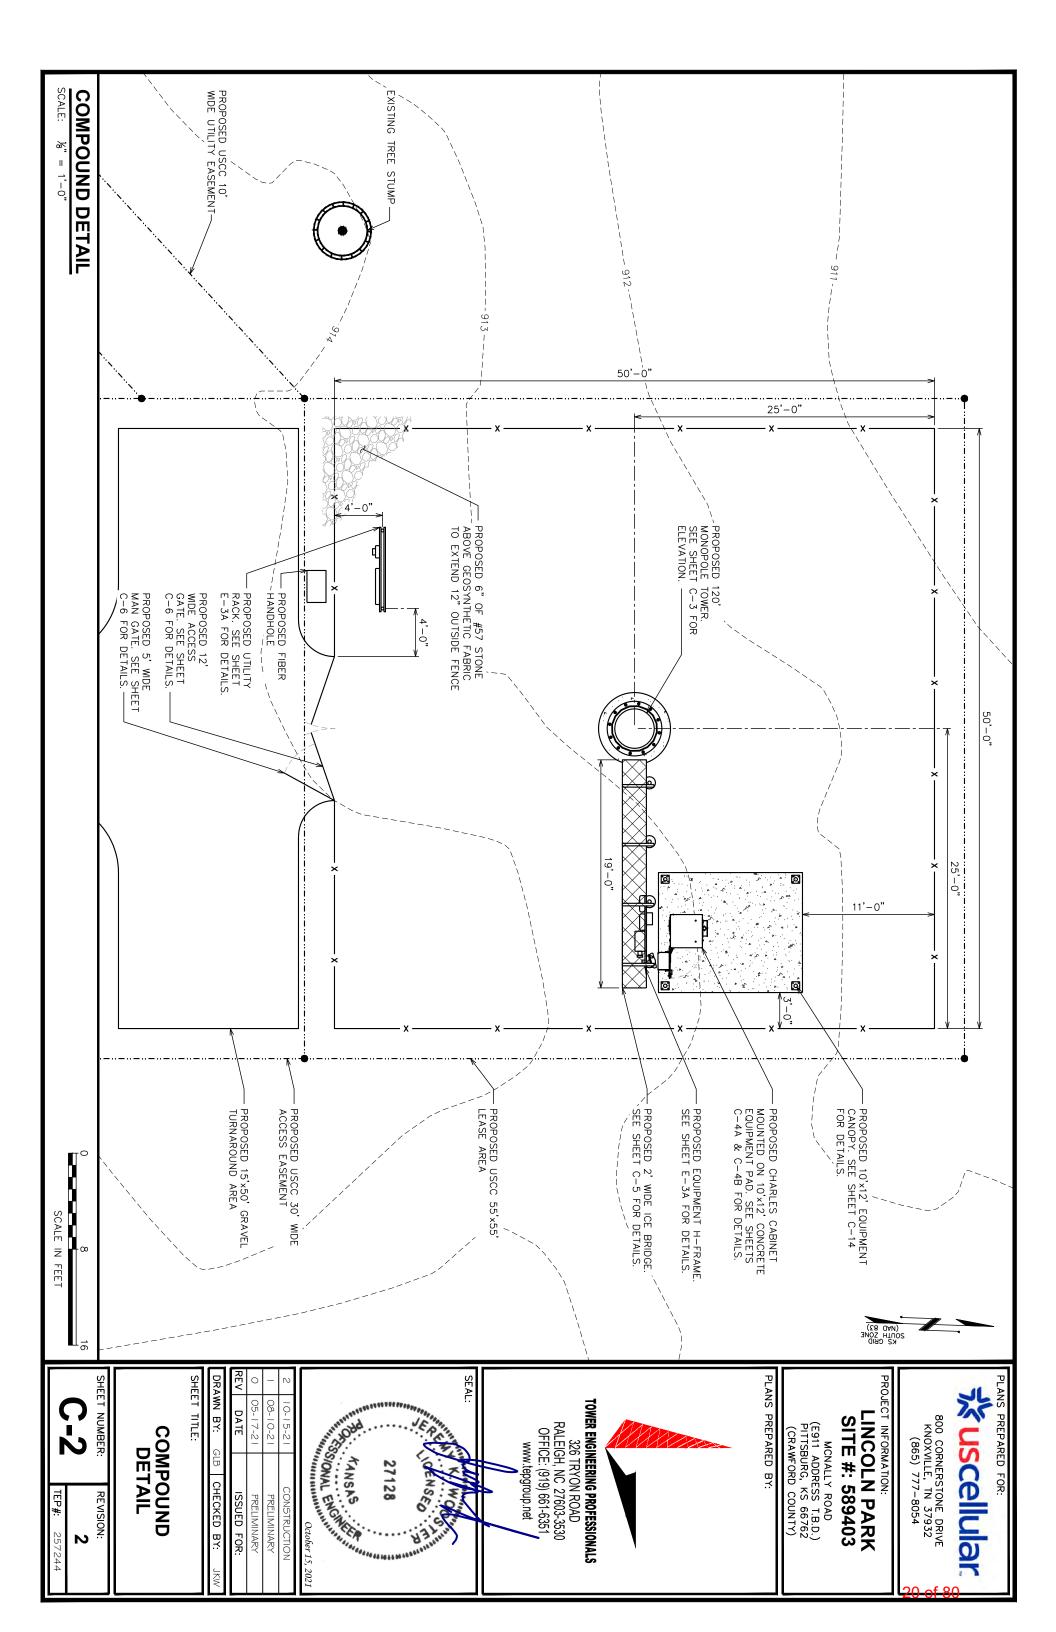

- PROPOSED CABLE TO BE RUN PER SPECIFICATIONS OF PASSING STRUCTURAL ANALYSIS.
- TOWER SHALL BE CONSTRUCTED OF GALVANIZED STEEL OR PAINTED PER APPLICABLE STANDARDS OF THE FAA OR OTHER APPLICABLE FEDERAL OR STATE AGENCY
- 3. TOWER ELEVATION SHOWN FOR REFERENCE ONLY. VERIFY ACTUAL TOWER DESIGN & LOADING WITH TOWER DRAWINGS FROM MANUFACTURER AND/OR PASSING STRUCTURAL ANALYSIS PRIOR TO CONSTRUCTION.

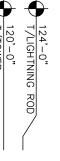

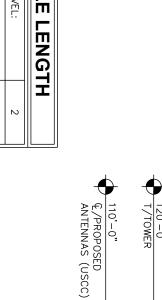


TOTAL EST. LENGTH OF HYBRID CABLE (ROUNDED UP): RAYCAP CENTERLINE + 20-FT BUFFER: ICE BRIDGE LENGTH: PROPOSED RAYCAP QUANTITY AT GROUND LEVEL: TOTAL ESTIMATED LENGTH OF HYBRID CABLE: **EUPEN HYBRID CABLE LENGTH JUMPER INFO** 130-FT 150-FT 149-FT 19-FT

10-M (32.8 FT)	10-M (32.8 FT)	10-M (32.8 FT) 10-M (32.8 FT) 10-M (32.8 FT)	GAMMA SECTOR:
10-M (32.8 FT)	10-M (32.8 FT)	10-M (32.8 FT) 10-M (32.8 FT) 10-M (32.8 FT)	BETA SECTOR:
10-M (32.8 FT)	10-M (32.8 FT)	10-M (32.8 FT) 10-M (32.8 FT) 10-M (32.8 FT)	ALPHA SECTOR:
BAND 71/12	BAND 5	BAND 2/4	
O RRU	FROM RAYCAP 1	FIBER/POWER JUMPER LENGTH FROM RAYCAP TO RRU	FIBER/POWER

25-FT	25-FT	25-FT	GAMMA SECTOR:
25-FT	25-FT	25-FT	BETA SECTOR:
25-FT	25-FT	25-FT	ALPHA SECTOR:
BAND 71/12	BAND 5	BAND 2/4	
	J TO ANTENNA	为" JUMPER FROM RRU TO ANTENNA	为"、

RET JUMPER INFO

	10-M (32.8 FT)	ALPHA SECTOR: 10-M (32.8 FT) 10-M (32.8 FT)	BAND 5 BAND 71/12	RRU TO ANTENNA
10-M (32.8 FT)	(32.8 FT) (32.8 FT)	(32.8 FT)	71/12	

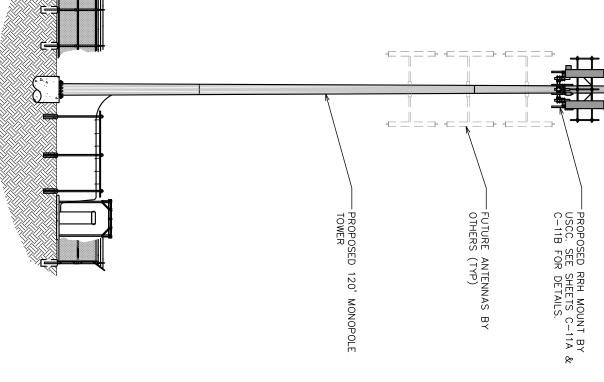



LINCOLN PARK SITE #: 589403

MCNALLY ROAD
(E911 ADDRESS T.B.D.)
PITTSBURG, KS 66762
(CRAWFORD COUNTY)

PROPOSED ANTENNAS BY USCC (TYP OF 5). SEE SHEETS C-10A & C-10B FOR DETAILS.


PROPOSED 4' LIGHTING ROD

PLANS PREPARED BY:

TOWER ENGINEERING PROFESSIONALS

326 TRYON ROAD RALEIGH, NC 27603-3530 OFFICE: (919) 661-6351

www.tepgroup.net

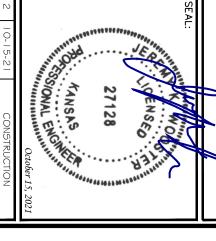

ISSUED FOR:	DATE	REV
PRELIMINARY	05-17-21	0
PRELIMINARY	08-10-21	1
CONSTRUCTION	10-15-21	2

SHEET
TITLE:

TOWER ELEVATION

က	HEET NUMBER:
1	REVISIO


ž

TOWER ELEVATION –; Ⅱ

20

SCALE:

SCALE IN FEET

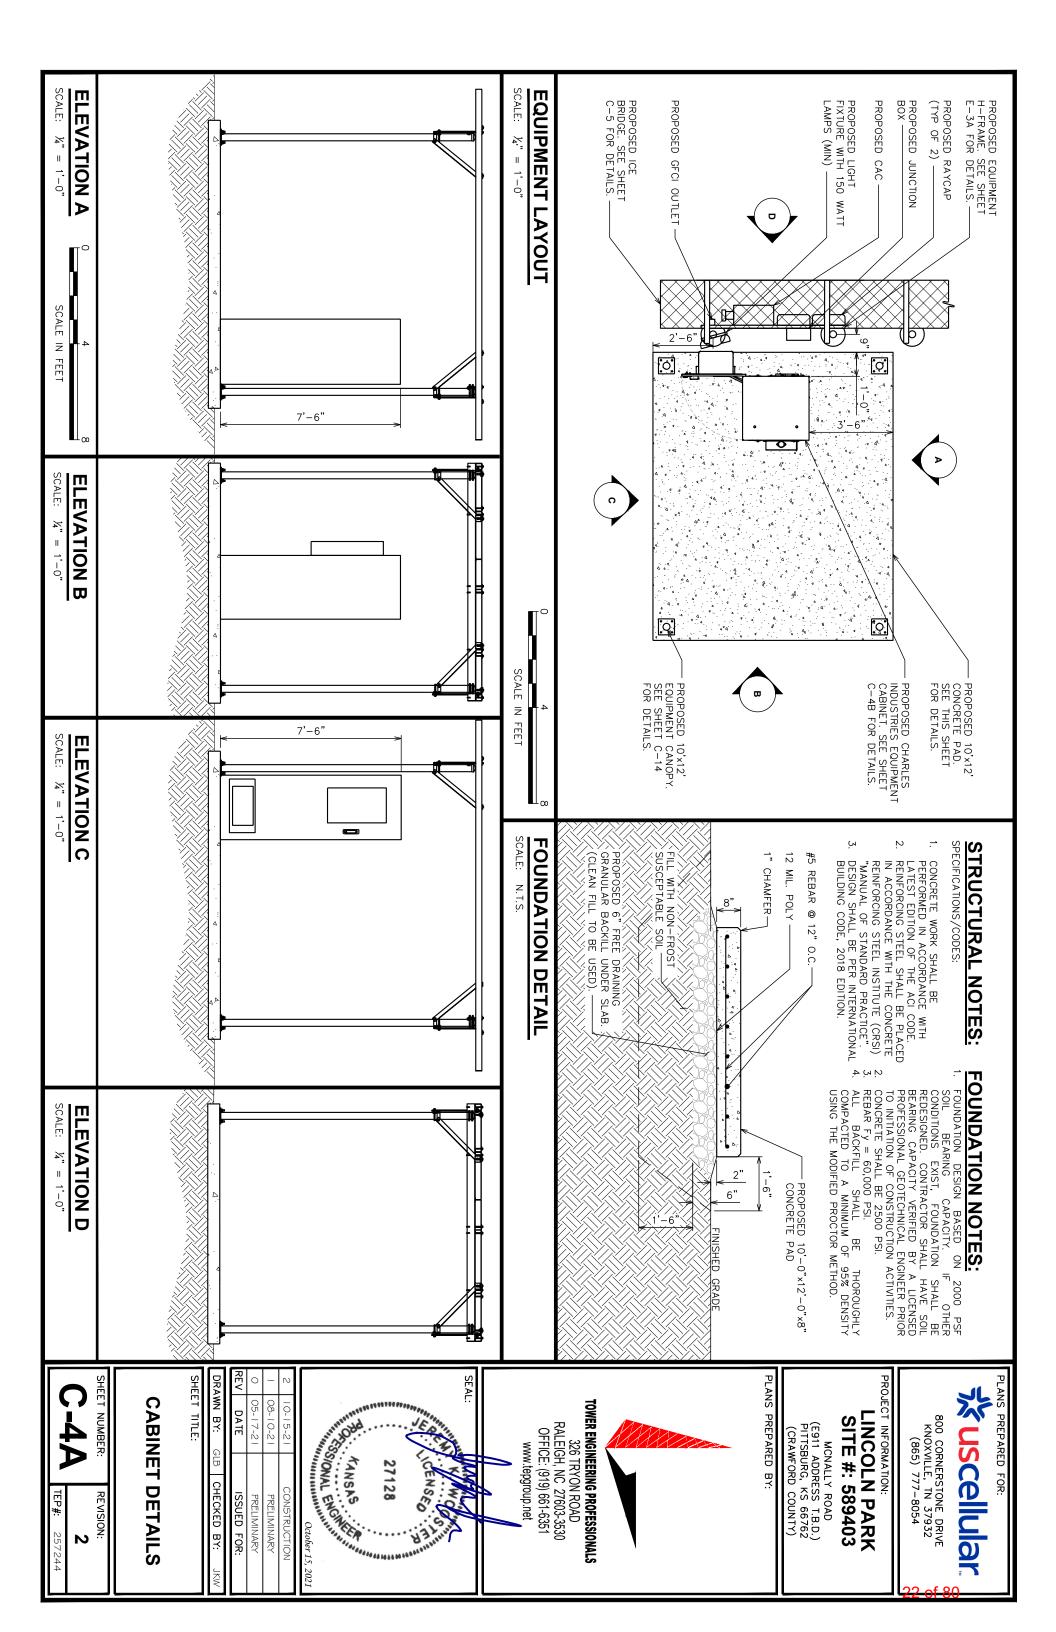

CHARLES CABINET DETAIL (CUBE-SS4B231UN4)

SCALE: N.T.S.

Page 2 of 5

2nd Printing

Figure 3 CUBE Components

LT-SS4B231UN4 24RU, 19" HORIZONTAL — RACK MOUNT WITH EIA HOLE SPACING ALARM TERMINAL PANEL (4) QTR TURN -216 STYLE LATCHES (4) QTR TURN 216 STYLE LATCHES (2) SHROUDS FOR – EMERGENCY DAC 3PT 216 STYLE-PADLOCKABLE DOOR HANDLE GFCI OUTLET (2) WIND LATCHES -(1 PER DOOR) (4) LIFTING BRACKETS DOOR ALARM SWITCH-(2) EXTERNAL GROUND STUDS WITH LUGS DOOR ALARM AND
HVAC CUTOFF SWITCHES SOLAR SHIELD - (2) 2X8 POSITION GROUND BARS (NOT VISIBLE IN THIS VIEW) - POWER SUPPLY HVAC SYSTEM 턴 OVERHEAT AND DAC CONTROL THERMOSTATS - (2) BATTERY RETAINER BRACKETS \(
\)
\(
(3)\)
BATTERY BREAKERS
\(
\)
\(
\)
\(
\) (2) BATTERY TRAYS -4RU, 19" VERTICAL RACK MOUNT WITH EIA HOLE SPACING ~3RU, 19" VERTICAL RACK MOUNT WITH EIA HOLE SPACING

TOWER ENGINEERING PROFESSIONALS

326 TRYON ROAD RALEIGH, NC 27603-3530 OFFICE: (919) 661-6351

www.tepgroup.net

%uscellular

CT INFORMATION: LINCOLN PARK SITE #: 589403

PLANS PREPARED BY:

MCNALLY ROAD
(E911 ADDRESS T.B.D.)
PITTSBURG, KS 66762
(CRAWFORD COUNTY)

800 CORNERSTONE DRIVE KNOXVILLE, TN 37932 (865) 777-8054


CABINET DETAILS

05-17-21 08-10-21

DATE


SSUED FOR: PRELIMINARY PRELIMINARY

SHEET NUMBER: C-4B REVISION:

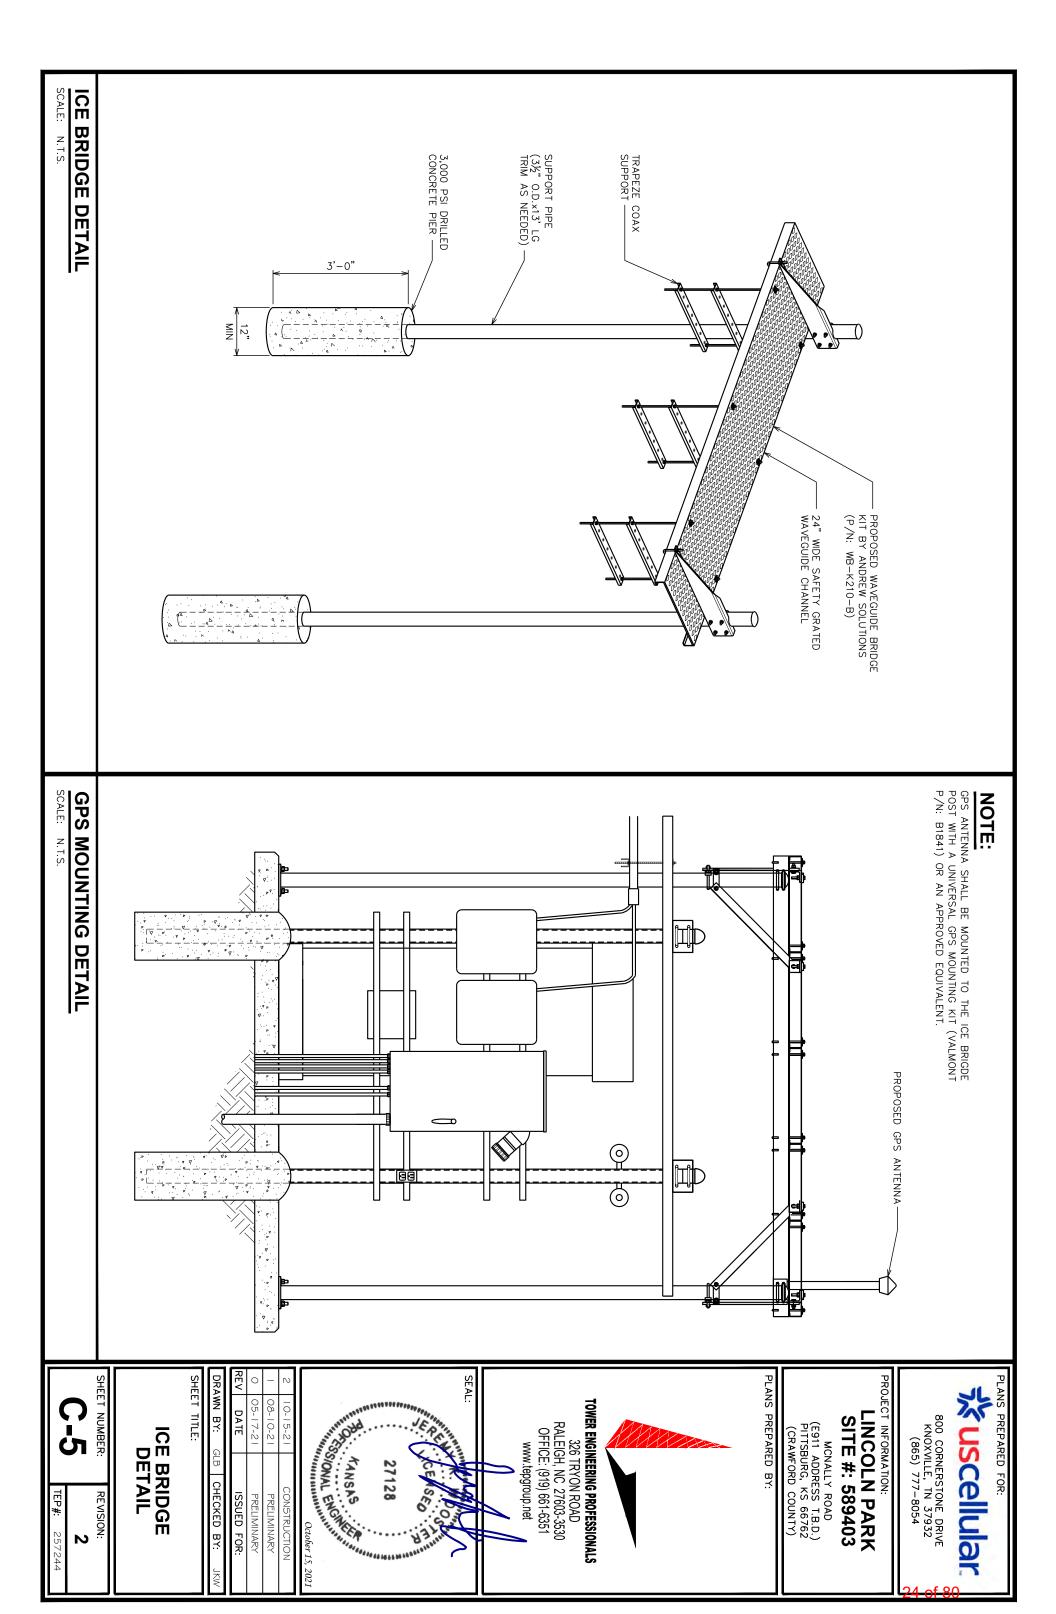

REVISION:

ISSUED FOR: PRELIMINARY PRELIMINARY

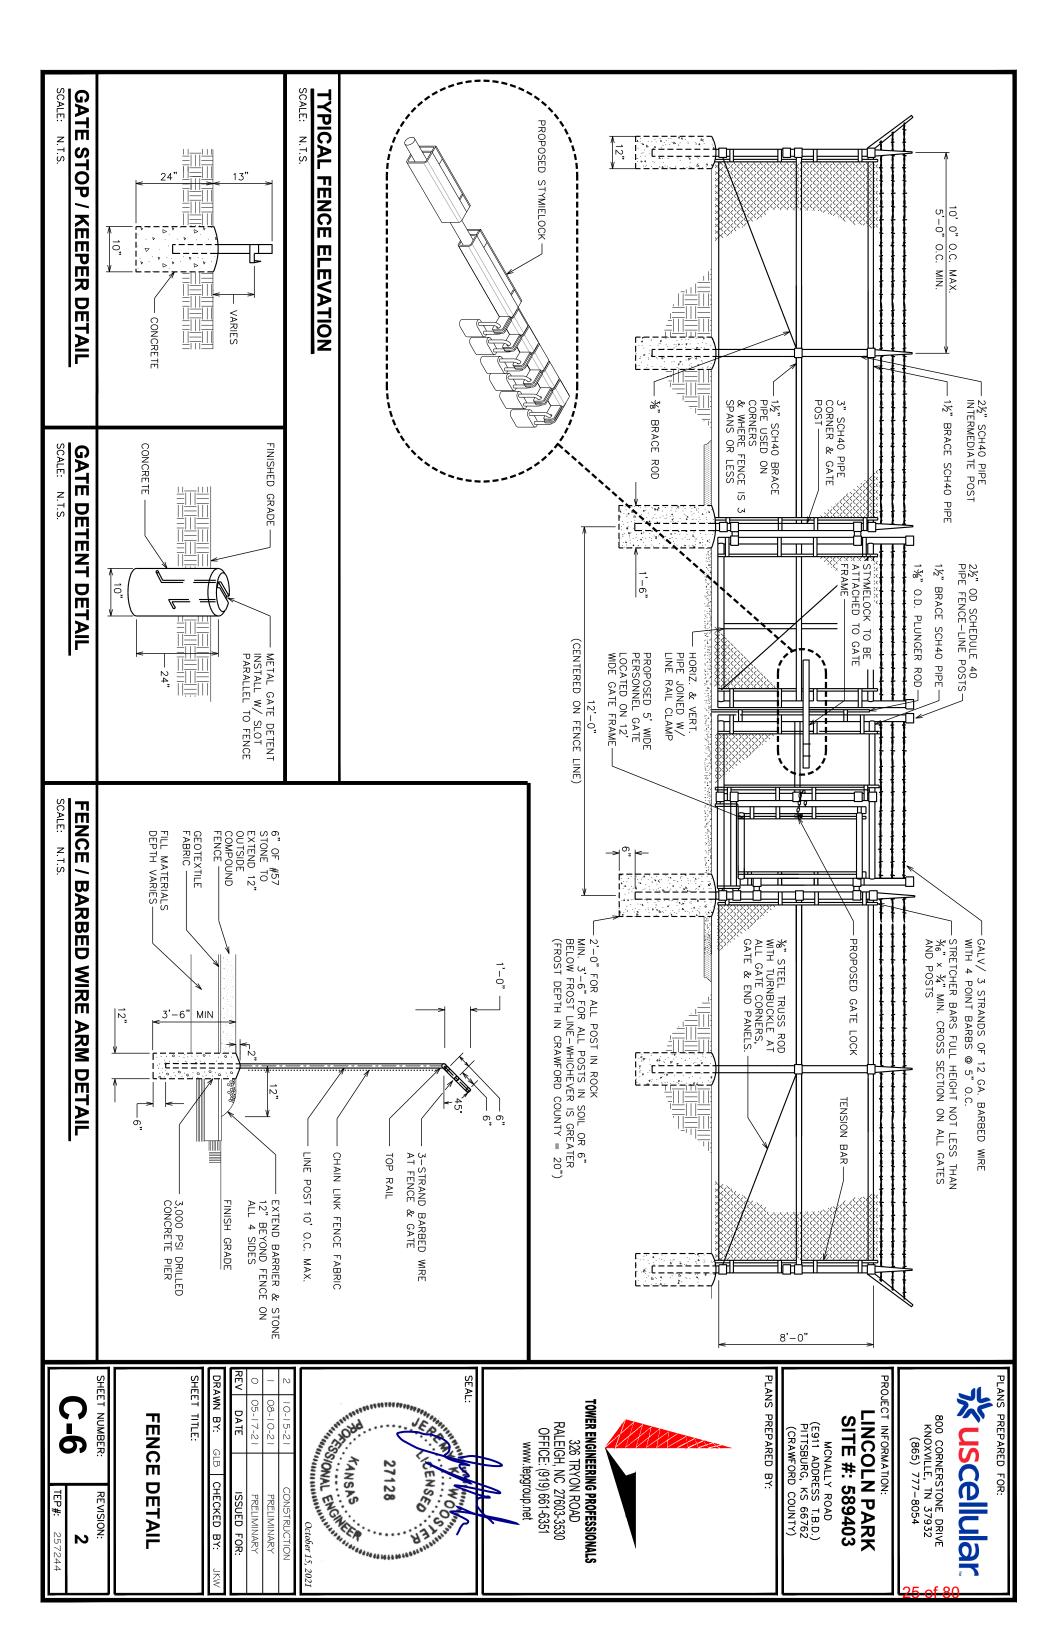

NOTES:

- SIGNS SHALL BE MADE OF ALUMINUM WITH 1/4" HOLES 1/2" FROM EACH CORNER TO HANG SIGNS ON FENCE.

SIGNS SHALL BE INSTALLED AS FOLLOWS:

GATE: NO TRESPASSING, RF GUIDELINES, RF WARNING, NFPA SULFURIC ACID, AUTHORIZED PERSONNEL ONLY
INTERIOR OF FENCE GATE: EXIT SIGN

SIGNS SHALL BE INSTALLED WITH CENTER AT 5' ABOVE FINISHED GRADE

THE FEDERAL OPERATIONS ZTRESPASSING LICENSED BY GOVERNMENT

PERSONS VANDALIZING THIS FACILITY WILL BE PROSECUTED UNDER APPLICABLE FEDERAL, STATE AND LOCAL LAWS.

PRIOR TO ENTRY OR IN CASE OF EMERGENCY CONTACT U.S. CELLULAR: (800) 510-6091

SITE NUMBER 589403

(1) NO TRESSPASSING SIGN (TO BE MOUNTED ON GATE) SIZE: 22"X 22" (0.063" ALUMINUM)

A NOTICE A RADIOFREQUENCY ENVIRONMENTS

All personnel should have electromagnetic energy (EME) awareness training.

All personnel entering this site must be authorized.
 Obey all posted signs.
 Assume all antennas are active.
 Assume all antennas are active.
 Before working on antennas, notify owners and disappropriate transmitters.

2 RF GUIDELINES SIZE: 6"X 4" (TO BE MOUNTED ON GATE)



Obey all posted signs and site guidelines for working in radio frequency environments.

AT CER L'INVIDI

(3) RF WARNING SIGN SIZE: 10"X 14"

(TO BE MOUNTED ON GATE)



4 NFPA SULFURIC ACID SIZE: 6.25"X 9" (TO BE MOUNTED ON GATE) SIGN



6 AUTHORIZED PERSONNEL ONLY SIGN (TO BE MOUNTED ON GATE) SIZE: 14"X 10"

(5) REFLECTIVE EXIT SIGN SIZE: 10"X 7"

(TO BE MOUNTED TO INTERIOR GATE FENCE)




800 CORNERSTONE DRIVE KNOXVILLE, TN 37932 (865) 777-8054

LINCOLN PARK SITE #: 589403 INFORMATION:

Sulfuric

Acid

MCNALLY ROAD
(E911 ADDRESS T.B.D.)
PITTSBURG, KS 66762
(CRAWFORD COUNTY)

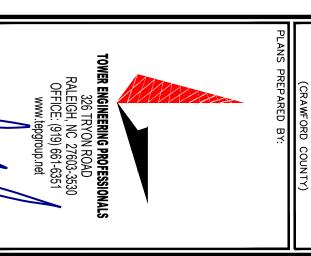


:SOED FOR	DATE	REV	
PRELIMINARY	05-17-21	0	
PRELIMINARY	08-10-21	_	
CONSTRUCTION	10-15-21	N	
27128 27128 October 15, 2021	A STATE OF THE PERSON OF THE P		
That I	į.	SEAL:	

			ו דודעב:	.33HS
Z	CHECKED BY:	GLB	DRAWN BY:	DRAW

SHEET NUMBER REVISION:

SIGNAGE DETAILS

TYPICAL SIGNS AND SPECIFICATIONS

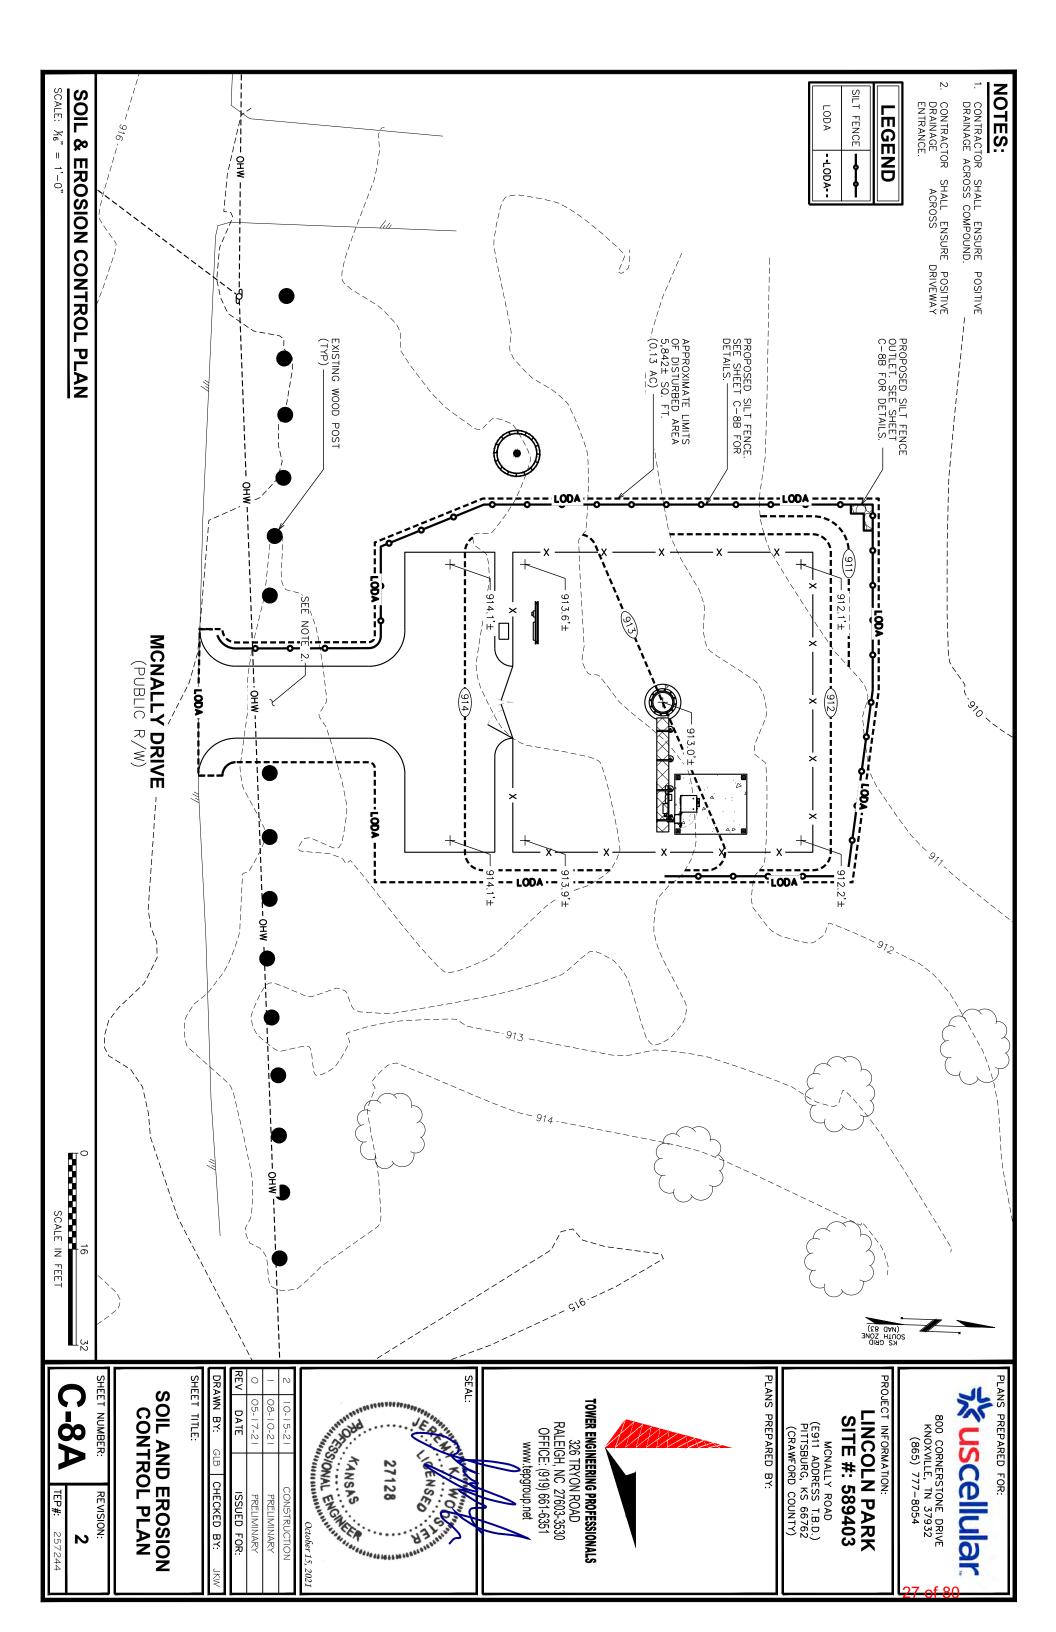


NOTES:

- FILTER FABRIC SHALL CONFORM TO THE REQUIREMENTS LISTED IN ASTM D 6461.
- 5 ENDS OF INDIVIDUAL FILTER FABRIC SHALL BE SECURELY FASTENED AT A SUPPORT POST WITH 4 FEET MINIMUM OVERLAP TO THE NEXT POST.
- PLACE 12 INCHES OF FABRIC ALONG THE BOTTOM AND SIDE OF THE TRENCH.


3


- INSPECT SEDIMENT FENCE(S) AT LEAST ONCE A WEEK AND AFTER EACH RAINFALL.
- ù REMOVE SEDIMENT DEPOSITS AS NECESSARY TO PROVIDE ADEQUATE STORAGE VOLUME FOR THE NEXT RAIN AND TO REDUCE PRESSURE ON THE
- 9 AFTER CONSTRUCTION IS COMPLETE, THE CONTRACTOR SHALL REMOVE ALL FENCING MATERIALS AND UNSTABLE SEDIMENT DEPOSITS, BRING THE AREA TO GRADE AND PROPERLY STABILIZE THE SITE.

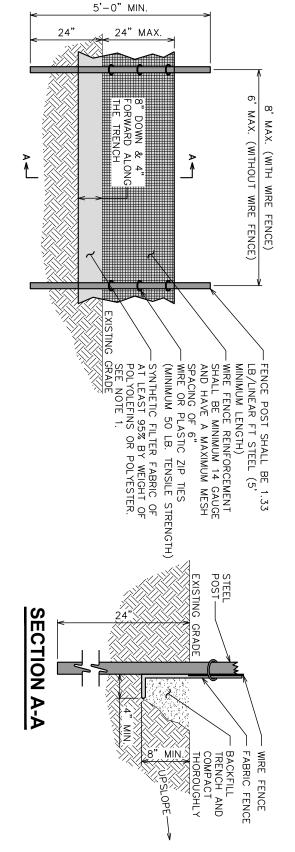

SILT FENCE DETAIL

N.T.S.

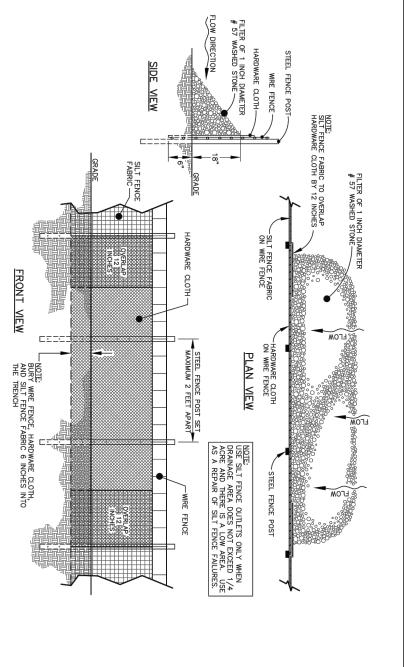

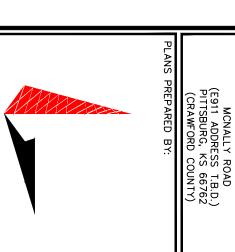

%uscellular

800 CORNERSTONE DRIVE KNOXVILLE, TN 37932 (865) 777-8054

PREPARED FOR:

CT INFORMATION:

LINCOLN PARK

SITE #: 589403

77.77.88.88	************	JEDONALIA	SEAL:	
AANSAS	27128	CENSED	W	//
	28	315		
October 15, 2021	943 16 7 9 90 7 9	Mare state		

ISSUED FOR:	DATE	REV
PRELIMINARY	05-17-21	0
PRELIMINARY	08-10-21	_
CONSTRUCTION	10-15-21	2
27128 ANSAS ASTRACTOR October 15, 2021	The state of the s	
CENSA	4	


40
SILT
TE E
LS

SHEET NUMBER: C-8B REVISION:

STANDARD

SILT FENCE OUTLET DETAIL

N

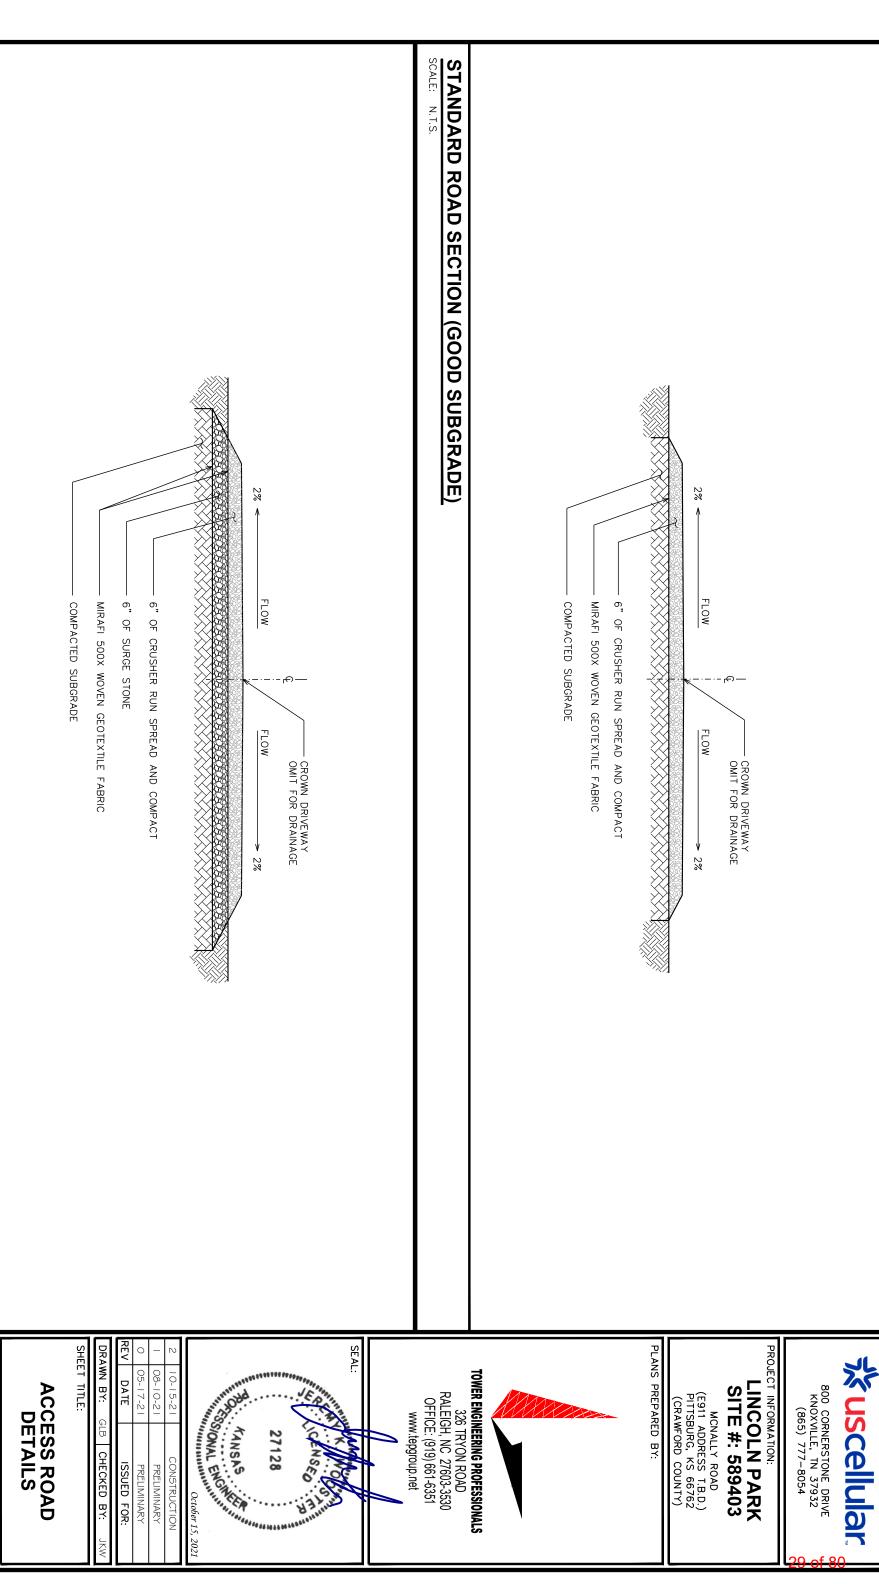

www.tepgroup.net

PLANS PREPARED FOR:

800 CORNERSTONE DRIVE KNOXVILLE, TN 37932 (865) 777-8054

LINCOLN PARK SITE #: 589403

MCNALLY ROAD
(E911 ADDRESS T.B.D.)
PITTSBURG, KS 66762
(CRAWFORD COUNTY)

ALTERNATIVE ROAD SECTION (POOR SUBGRADE)

SHEET NUMBER:


ACCESS ROAD DETAILS

05-17-21

DATE

SSUED FOR: PRELIMINARY PRELIMINARY

C-9

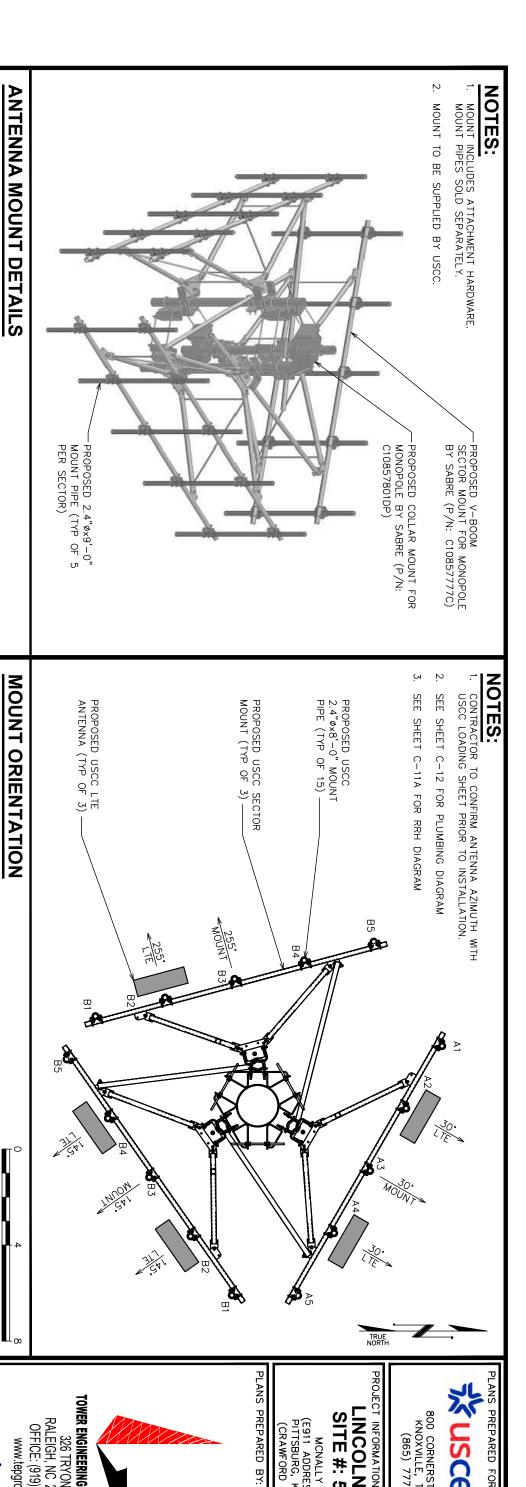

% uscellular

800 CORNERSTONE DRIVE KNOXVILLE, TN 37932 (865) 777-8054

LINCOLN PARK

INFORMATION:

SITE #: 589403

MCNALLY ROAD (E911 ADDRESS T.B.D.) PHTTSBURG, KS 66762 (CRAWFORD COUNTY)

PREPARED FOR:

ANTENNA/CABLE SCHEDULE

SCALE: $\frac{1}{4}$ " = 1'-0"

SCALE IN FEET

TOWER ENGINEERING PROFESSIONALS

326 TRYON ROAD RALEIGH, NC 27603-3530 OFFICE: (919) 661-6351

www.tepgroup.net

SEAL:

SCALE:


N.T.S.

						₹						
ANTENNA	SECTOR	ТЕСН	MANUFACTURER (MODEL #)	AZIMUTH (TRUE NORTH)	MOUNTING HEIGHT	ELECT. D-TILT	MECH. D-TILT	EQUIPMENT	SURGE PROTECTION	COAX/CABLE	CABLE LENGTH*	COAX JUMPER*
A2	ALPHA	LTE	DENGYO OCT8—2LX2HX—BW65	30°	€ @ 110'-0"	-	Ī					25'±
Α4	ALPHA	LTE	DENGYO OCT8—2LX2HX—BW65	30°	€ @ 110'-0"	-	Ī	(3) NOKIA AHLOA RRH				25'±
B2	BETA	LTE	DENGYO OCT8-2LX2HX-BW65	145°	€ @ 110'-0"	-	-	(2) NOKIA AHCA RRH	(2) RUSDC-6267-PF-48 RAYCAP	(2) RUSDC-6267-PF-48 (2) 1½"Ø HYBRID CABLE RAYCAP	150'±	25'±
B4	BETA	LTE	DENGYO OCT8-2LX2HX-BW65	145°	€ @ 110'-0"	1	ı	(3) NOKIA AHFIB RRH				25'±
C2	GAMMA	LTE	DENGYO OCT8-2LX2HX-BW65	255*	€ @ 110'-0"	I	ı					25'±

OF (5) ANTENNAS.

NOTES: 1. *CONTRACTOR SHALL FIELD VERIFY HYBRID CABLE AND COAX JUMPER LENGTHS PRIOR TO ORDERING MATERIALS. 2. (2) ANTENNA PER SECTOR FOR SECTORS ALPHA AND BETA AND (1) ANTENNA FOR SECTOR GAMMA FOR A TOTAL 3. CONTRACTOR TO VERIFY AZIMUTHS PRIOR TO CONSTRUCTION. 4. CONTRACTOR TO REQUEST RF SHEET FROM CONSTRUCTION MANAGER PRIOR TO CONSTRUCTION.

RF CONFIGURATION

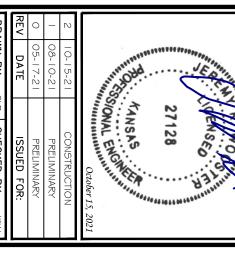


	2	ř
	Ħ	
	9	ŗ
7 11 1	NNA	
ä	<u>></u>	
>	<u>₹</u>	
n	۲	
	ž	
	글	
	6	
	_,	

DEIAILS

N

C-10A

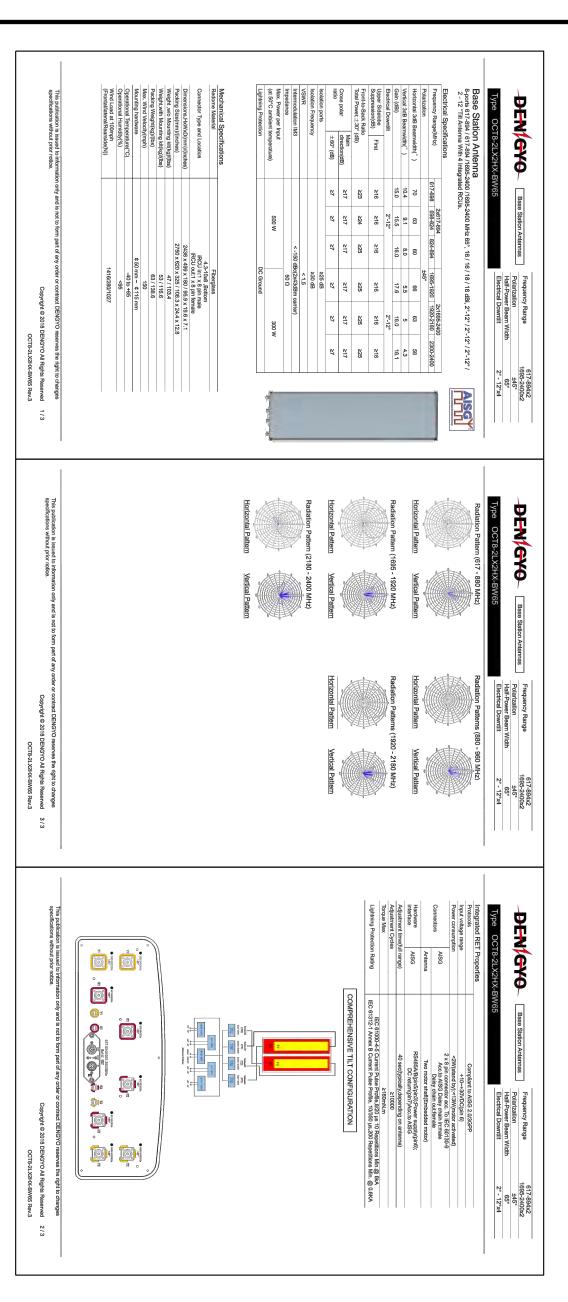




PROJECT INFORMATION: LINCOLN PARK SITE #: 589403

MCNALLY ROAD
(E911 ADDRESS T.B.D.)
PITTSBURG, KS 66762
(CRAWFORD COUNTY)

PLANS PREPARED BY:

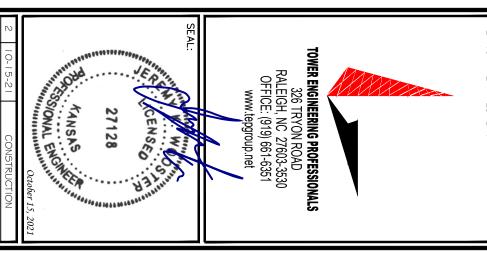

		I
ISSUED FOR:	DATE	REV
PRELIMINARY	05-17-21	0
PRELIMINARY	08-10-21	1
CONSTRUCTION	12-51-01	2

אוני
=======================================


ANTENNA DETAILS

REVISION:

C-10B

ANTENNA DETAILS

SCALE: N.T.S.

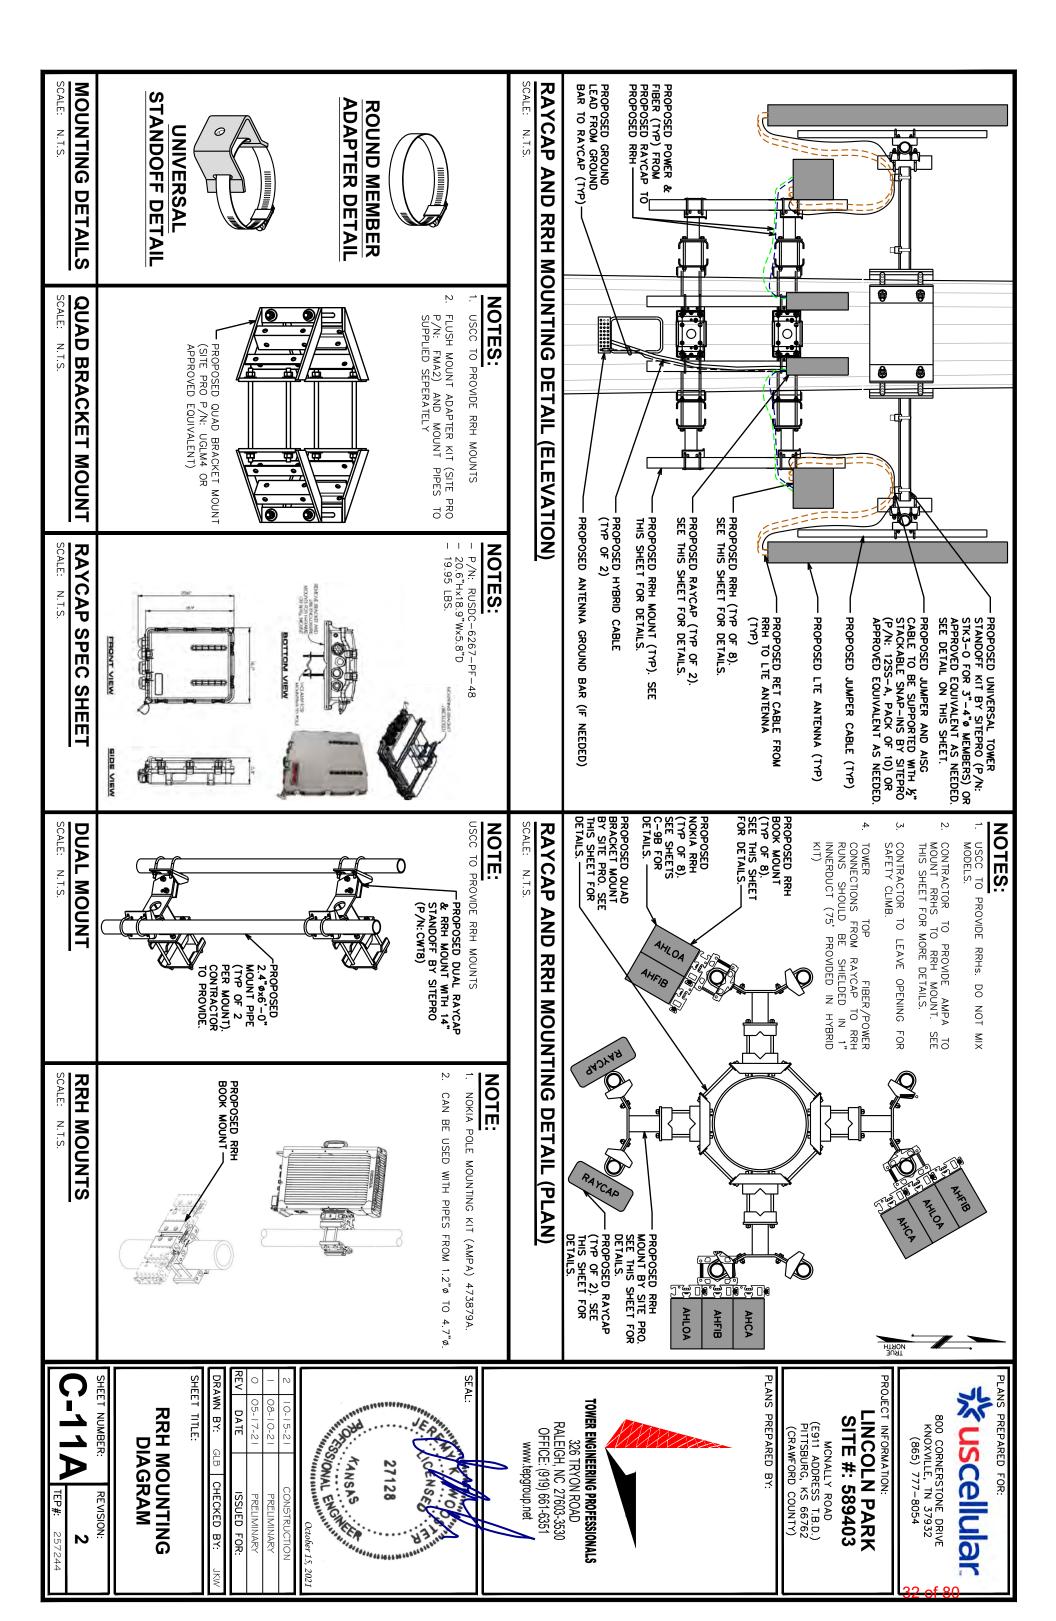



NOKIA

Product name	AirScale Dual RRH 4T4R B12/71 240W AHLOA
Supported frequency bands	3GPP bands 12 and 71
Frequencies	Band 85 (12,17): UL 698 – 716 MHz, DL 728 – 746 MHz Band 71: UL 663 MHz – 698 MHz, DL 617 MHz – 652 MHz
Number of TX/RX ports	4 pipes, 2T2R, 2T4R, 4T4R for both bands
Instantaneous Bandwidth IBW	17 MHz for B12 and 35MHz for B71 1 MHz NB IoT future use in B85
Occupied Bandwidth OBW	UL 53MHz contiguous DL B12 17MHz + 1 MHz NB IOT future use: B71 35MHz
Output power	60W per TX shared between bands
Supply Voltage / Voltage Range	DC-48 V / -36 V to -60 V
Typical power consumption	664W [ETSI Busy Hour Load at 4TX@60W] 465W [ETSI Busy Hour Load at 4TX@20W]
Antenna ports	4 ports, 4.3-10
Optical ports	2 x CPRI 9.8 Gbps
ALD control interfaces	AISG3.0 and RET (DC on ANT1 & ANT3)
Other interfaces	External alarm MDR-26 serial connector (4 inputs, 1 output)
	DC circular power connector
Operational temperature range	-40°C to 55°C (with no solar load)
Dimensions (mm) height x width x depth	560 x 308 x 189
Volume (liters)	32.5
Weight (kg)	38
Ingress protection class	IP65
Installation options	Pole or Wall, vertical or horizontal book mount
Surge protection	Class II 5kA



NOKIA

Product name	AirScale Dual RRH 4T4R 825/66/320W, AHFIB - 4742164
Supported Frequency bands.	3GPP Bands 2's and 66
Erequencies	8and 25-0t 1930-1995MHz, Ut 1850-1915MHz 8and 66: 0t 2110-2200MHz, Ut 1710-1780MHz
llumber of TX/RX ports	4/4
instantaneous Bandwidth iBW	Band 25/Band 66 - full band
Occupied Bendwigth OBW	Band 25 full band, Band 66: BOMME
Output Power	40W per band, 80W per TX
Supply Voltage / Voltage Pange	DC-48 V / -36V to -60V
Typical Power Consumption	525W (ETS) 24h Avg - 4x20W per band, 40W per TX port)
Antenna Rorts	4 ports, 4.3-10+
Optical Ports	2 x CPR 9.8 Gbps
ALD Control interfaces	A1503.0 from At IT 1,2,3,4 and RET (Pomer supply ATITT and ATITS)
Other Interfaces	External Alarm MD9-26 Serial connector (4 inputs, 5 Dutput) DC Circular Power Connector
Operational Temperature Range	-40°C to 55°C (with no solar load)
Dimensions Irvail Height x width x depth	560x308x1x9 mm (without covers or mounting bracket)
Volume (liters)	< 26 (nithout covers or mounting bracket)
Weight (kg)	< 30 (without covers or mounting bracket)
ingress protection sless	1965
installation options	Poly, Walt Book mount: Vertical wall/poly, Monzontal wall
Surge protection	E1835 II 54A

TOWER ENGINEERING PROFESSIONALS
326 TRYON ROAD
RALEIGH, NC 27603-3530
OFFICE: (919) 661-6351

www.tepgroup.net



RRH SPEC SHEETS

NOKIA

05-17-21 08-10-21

DATE

ISSUED FOR: PRELIMINARY PRELIMINARY

Produce many	ANTONISE XXX 414X GU IDES ANTONI 4 ANTONIOS
Supported frequency bands	3GPP hand 5
Frequencies	DL 869-894MHz, UL 824-849MHz
Number of TX/RX parts	4/4
Instantaneous Bandwidth IBW	ZSMHZ
Occupied Bandwidth OBW	25HHZ
Output power	474R 40 W/ 274R 80W
Dimensions (mim) height x width x depth	337 x 295 x 165
Volume (iters)	16.4
Weight IN)	16,7
Supply Vortage / Voltage Range	DC-48V/-36V to -60V
Typical Power Consumption	201 W JETSI Z4h Avg 4x20W mode)
Antenna ports	ATX/ARX, 4,5-10+
Optical ports	2 x CPRI 9.8 Gbp¢
ALD control interfaces	ASSGS 0 from ANT1, 2, 3, 4 and RET (Power supply ANT1 and ANT3)
Other interfaces	External altern MDR-26 senal connector (4 inputs, 1 autput) DC circular power connector
Operational temperature range	-40°C to 55°C (with no soler load)
ingress protection class.	IP65
Installation options	Pole or wall, RAS, vertical or horizontal book mount
Surge protection	Class II 5kA



PROJECT INFORMATION:
LINCOLN PARK
SITE #: 589403


PLANS PREPARED BY:


MCNALLY ROAD
(E911 ADDRESS T.B.D.)
PITTSBURG, KS 66762
(CRAWFORD COUNTY)


800 CORNERSTONE DRIVE KNOXVILLE, TN 37932 (865) 777-8054


C-11B REVISION:

RRH SPEC SHEETS

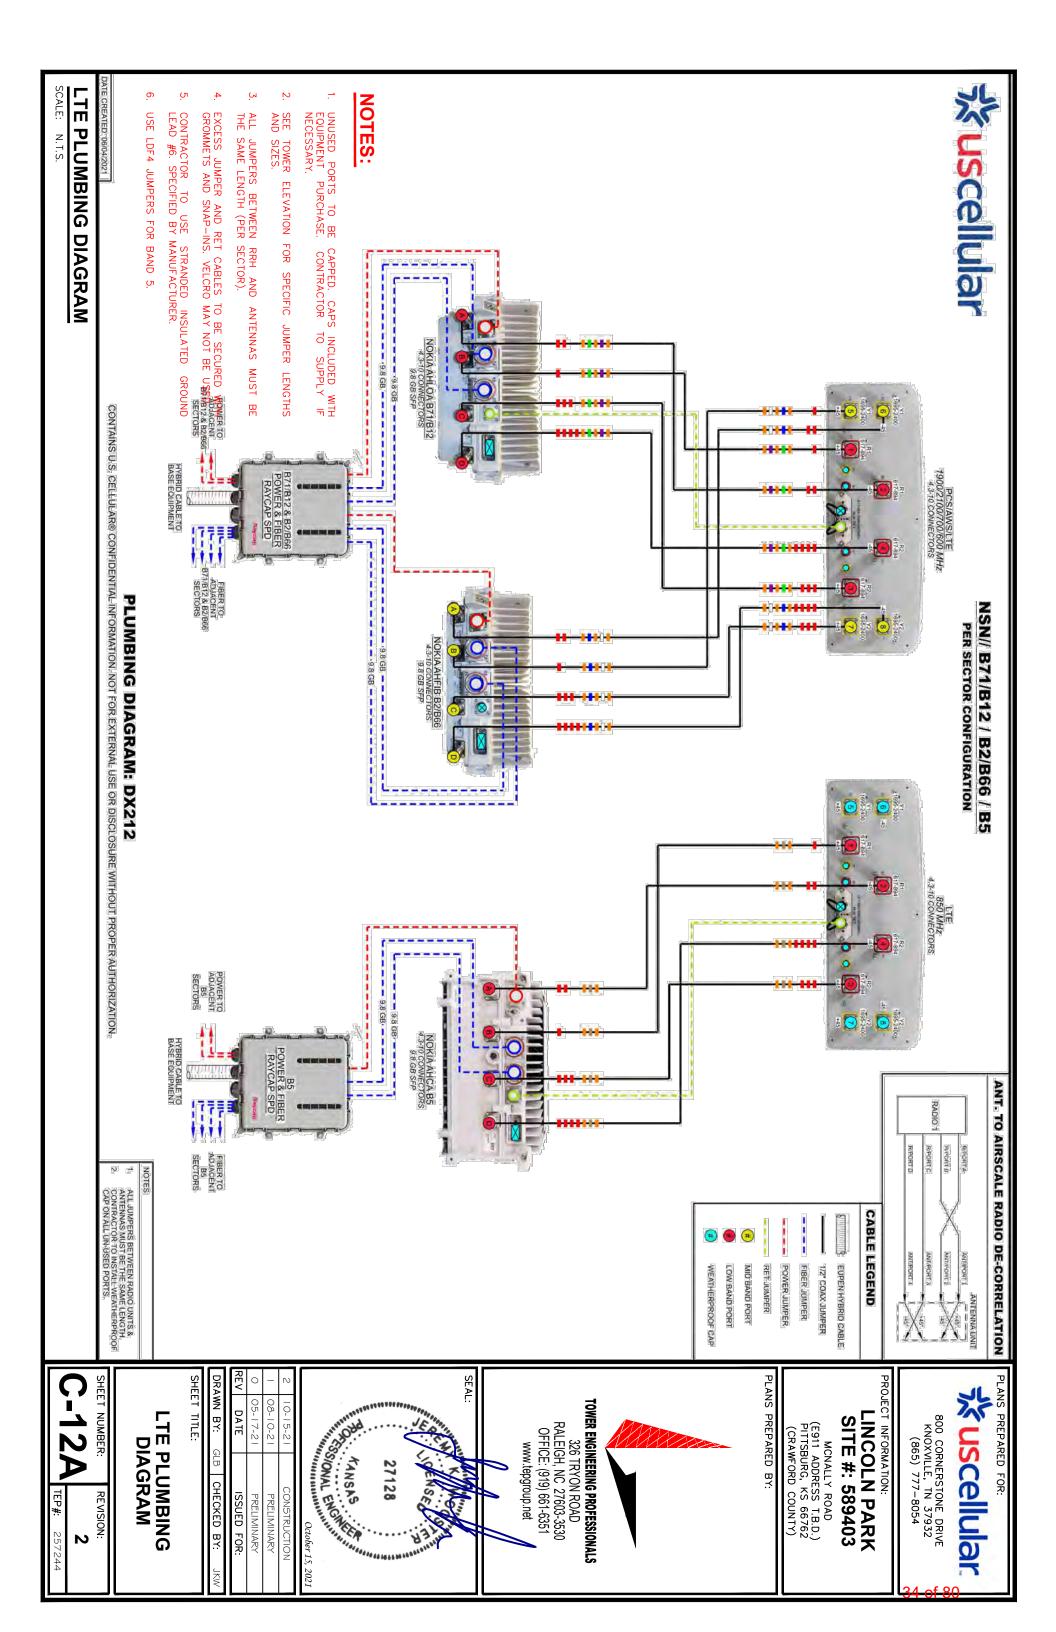

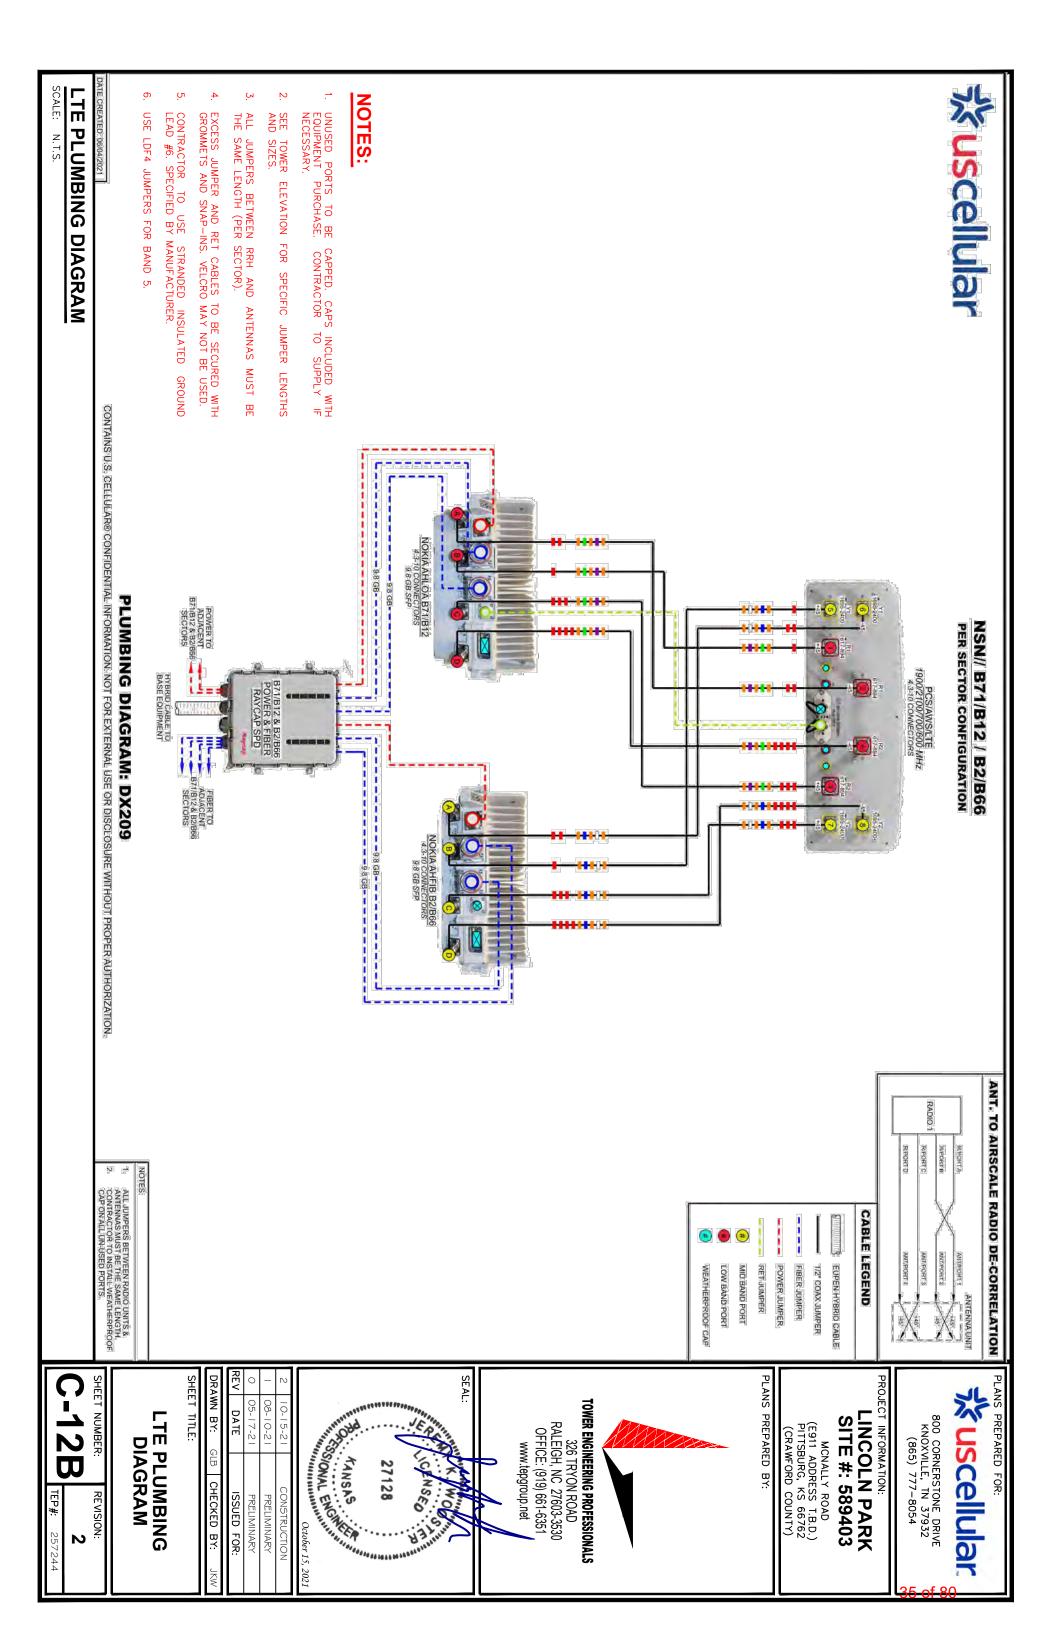

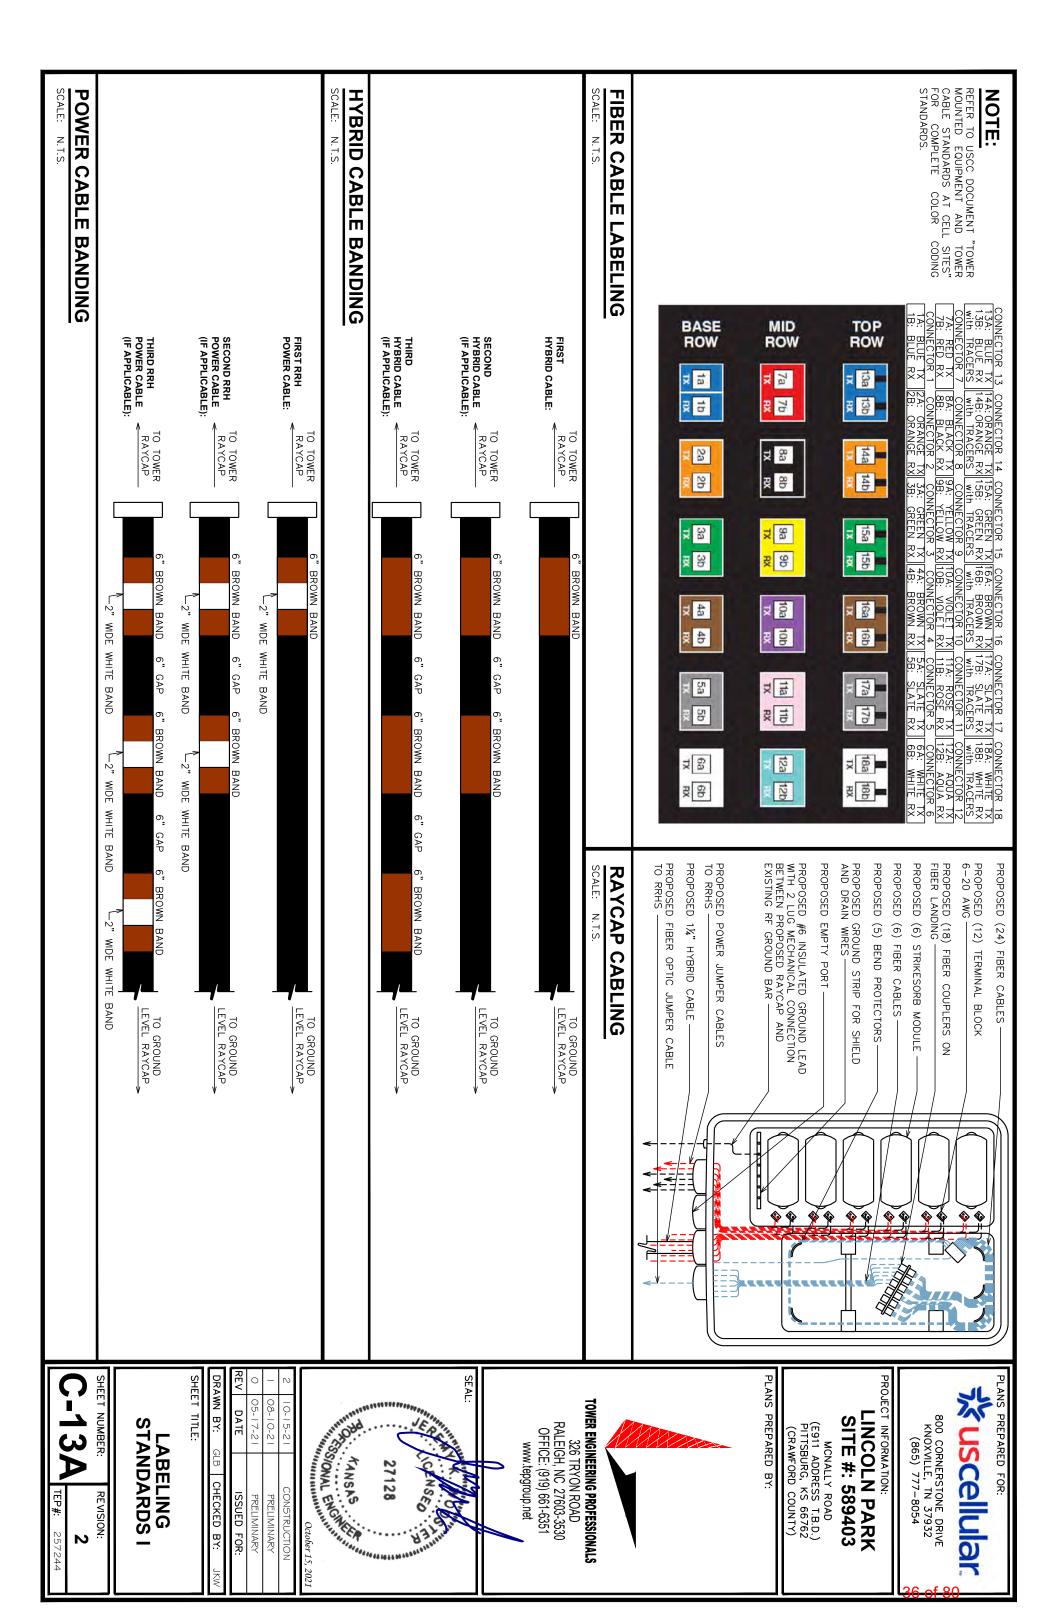

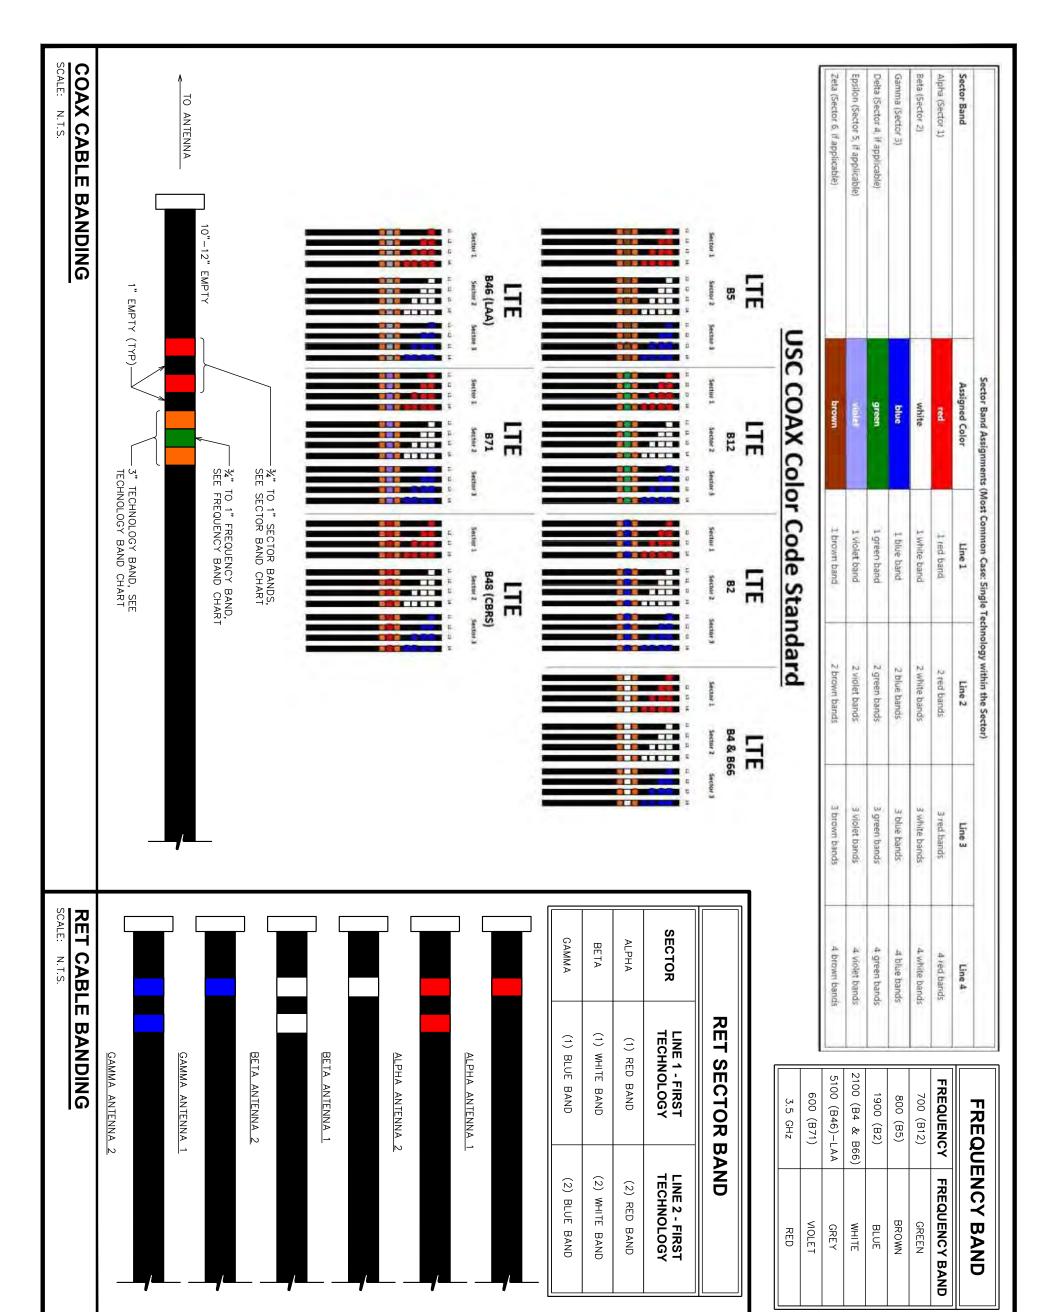

SEAL:

TOWER ENGINEERING PROFESSIONALS

326 TRYON ROAD RALEIGH, NC 27603-3530 OFFICE: (919) 661-6351

www.tepgroup.net

A 128

05-17-21 08-10-21

PRELIMINARY PRELIMINARY

FOR:

DATE

PLANS PREPARED BY:

MCNALLY ROAD
(E911 ADDRESS T.B.D.)
PITTSBURG, KS 66762
(CRAWFORD COUNTY)

PLANS PREPARED FOR:

%uscellular


800 CORNERSTONE DRIVE KNOXVILLE, TN 37932 (865) 777-8054

LINCOLN PARK

SITE #: 589403

STANDARDS II

LABELING

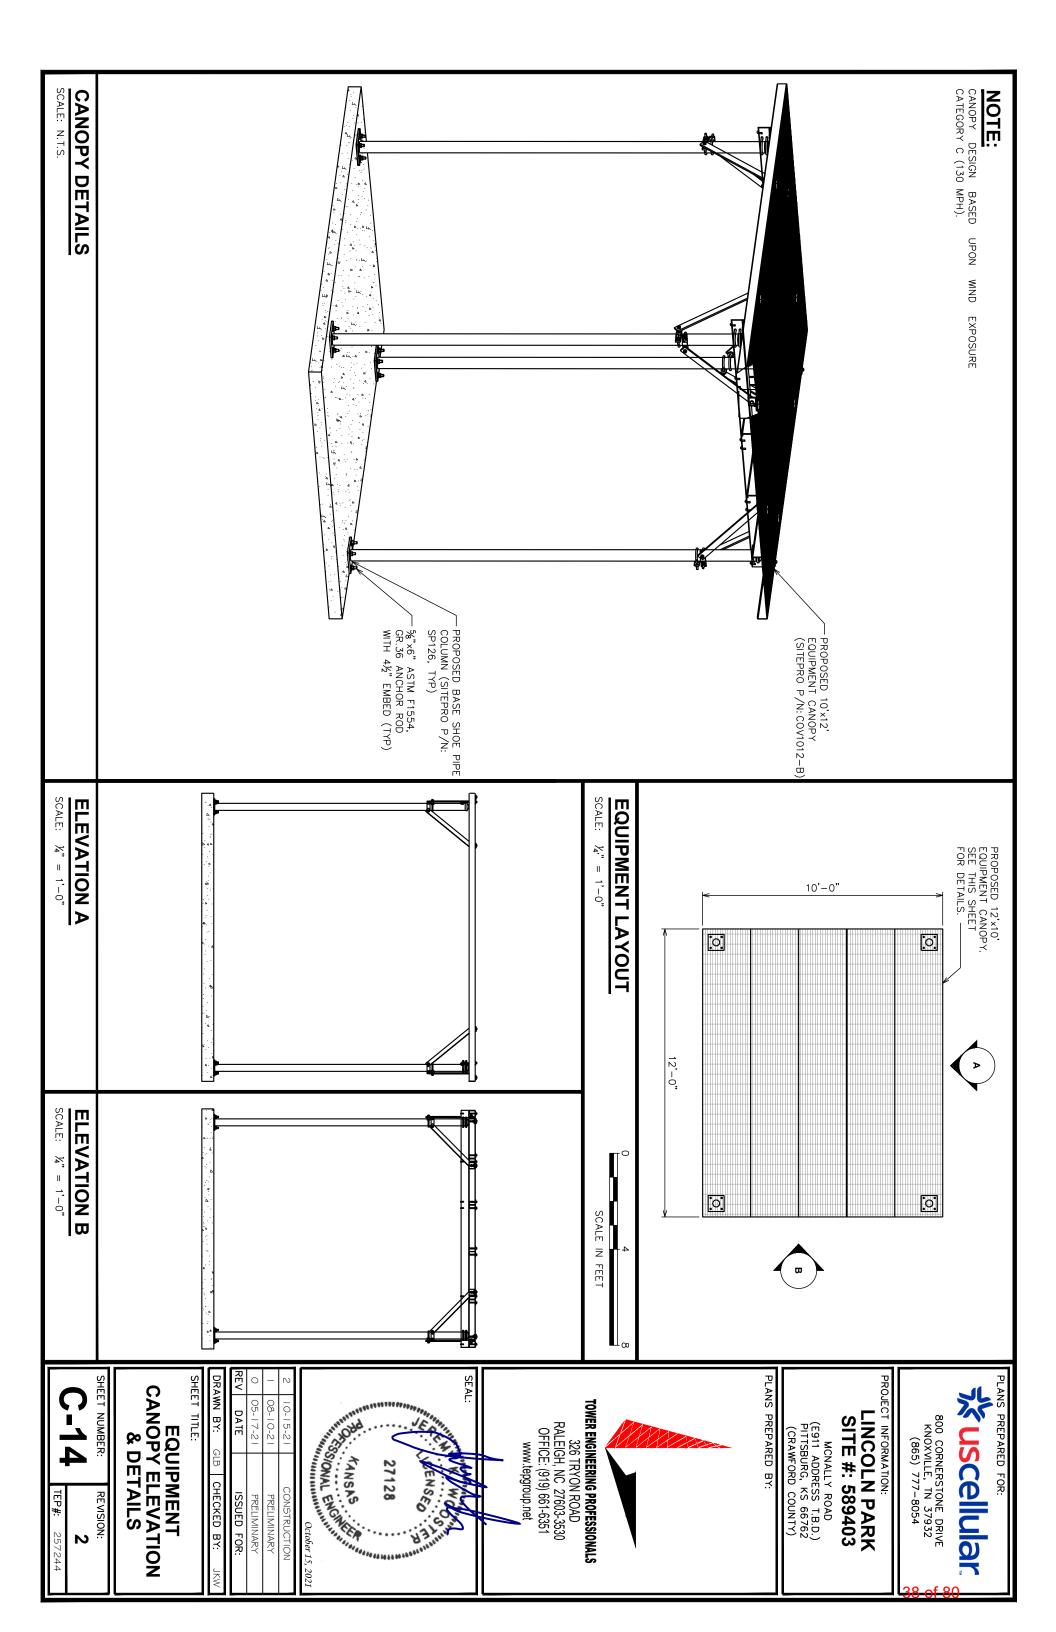

PROVIDE LABOR, MATERIALS, INSPECTION, AND TESTING TO ELECTRIC, TELEPHONE, AND GROUNDING/LIGHTNING SYSTEMS. PROVIDE CODE COMPLIANCE FOR

CODES:

- 1. THE INSTALLATION SHALL COMPLY WITH APPLICABLE LAWS AND CODES. THESE INCLUDE NOT LIMITED TO THE LATEST ADOPTED EDITIONS OF:

 A. THE NATIONAL ELECTRICAL SAFETY CODE
 B. THE NATIONAL ELECTRIC CODE NFPA—70
 C. REGULATIONS OF THE SERVING UTILITY COMPANY

 IEC (WHERE APPLICABLE) BUT

- LOCAL AND STATE AMENDMENTS
 THE INTERNATIONAL ELECTRIC CODE
 IEC (WHERE APPLICABLE)

2. PERMITS REQUIRED SHALL BE OBTAINED BY THE CONTRACTOR.

AFTER COMPLETION AND FINAL INSPECTION OF THE WORK, THE OWNER SHALL BE FURNISHED CERTIFICATE OF COMPLETION AND APPROVAL.

1. UPON COMPLETION OF THE INSTALLATION, OPERATE AND ADJUST THE EQUIPMENT AND SYSTEMS TO MEET SPECIFIED PERFORMANCE REQUIREMENTS. THE TESTING SHALL BE DONE BY QUALIFIED PERSONNEL.

GUARANTEE:

- 1. IN ADDITION TO THE GUARANTEE OF THE EQUIPMENT BY THE MANUFACTURER, EACH PIECE OF EQUIPMENT SPECIFIED HEREIN SHALL ALSO BE GUARANTEED FOR DEFECTS OF MATERIAL OR WORKMANSHIP OCCURRING DURING A PERIOD OF ONE (1) YEAR FROM FINAL ACCEPTANCE OF THE WORK BY THE OWNER AND WITHOUT EXPENSE TO THE OWNER.
- THE WARRANTEE CERTIFICATES & GUARANTEES FURNISHED BY THE MANUFACTURERS SHALL BE TURNED OVER TO THE OWNER.

UTILITY CO-ORDINATION:

1. CONTRACTOR SHALL COORDINATE WORK WITH THE POWER AND TELEPHONE COMPLY WITH THE SERVICE REQUIREMENTS OF EACH UTILITY COMPANY. COMPANIES AND SHALL

EXAMINATION OF SITE:

1. PRIOR TO BEGINNING WORK, THE CONTRACTOR SHALL VISIT THE SITE OF THE JOB AND SHALL FAMILIARIZE HIMSELF WITH THE CONDITIONS AFFECTING. THE PROPOSED ELECTRICAL INSTALLATION AND SHALL MAKE PROVISIONS AS TO THE COST THEREOF. FAILURE TO COMPLY WITH THE INTENT OF THIS SECTION WILL IN NO WAY RELIEVE THE CONTRACTOR OF PERFORMING THE WORK NECESSARY FOR A COMPLETE AND WORKING SYSTEM OR SYSTEMS.

CUTTING, PATCHING AND EXCAVATION:

- 1. COORDINATION OF SLEEVES, CHASES, ETC., BETWEEN SUBCONTRACTORS WILL BE REQUIRED PRIOR TO THE CONSTRUCTION OF ANY PORTION OF THE WORK. CUITING AND PATCHING OF WALLS, PARTITIONS, FLOORS, AND CHASES IN CONCRETE, WOOD, STEEL OR MASONRY SHALL BE DONE AS PROVIDED ON THE DRAWINGS.
- NECESSARY EXCAVATIONS AND BACKFILLING INCIDENTAL TO THE ELECTRICAL WORK SHALL BE PROVIDED BY THE ELECTRICAL CONTRACTOR UNLESS SPECIFICALLY NOTED OTHERWISE ON THE DRAWING.
- 3. SEAL PENETRATIONS THROUGH RATED WALLS, FLOORS, ETC., WITH APPROVED METHOD AS LISTED BY UL

RACEWAYS / CONDUITS GENERAL:

- CONDUCTORS SHALL BE INSTALLED IN LISTED RACEWAYS. CONDUIT SHALL BE RIGID SCH40 PVC, OR SCH80PVC AS INDICATED ON THE DRAWINGS. THE RACEWAY SYSTEM SHALL COMPLETE BEFORE INSTALLING CONDUCTORS. STEEL, EMT, BE COMPLETE
- EXTERIOR RACEWAYS AND GROUNDING SLEEVES SHALL BE SEALED AT POINTS THE RACEWAY SYSTEM SHALL BE BONDED PER NEC. OF ENTRANCE AND

EXTERIOR CONDUIT:

- EXPOSED CONDUIT SHALL BE NEATLY INSTALLED AND RUN PARALLEL OR PERPENDICULAR TO STRUCTURAL ELEMENTS. SUPPORTS AND MOUNTING HARDWARE SHALL BE HOT DIPPED GALVANIZED STEEL.
- THE CONDUIT SHALL BE RIGID STEEL AT GRADE TRANSITIONS OR WHERE EXPOSED TO DAMAGE
- 3. UNDERGROUND CONDUITS SHALL BE RIGID STEEL, SCH40 PVC, OR SCH80 PVC AS INDICATED ON THE DRAWINGS
- BURIAL DEPTH OF CONDUITS SHALL BE AS REQUIRED BY CODE FOR EACH SPECIFIC CONDUIT TYPE AND APPLICATION, BUT SHALL NOT BE LESS THAN THE FROST DEPTH AT THE SITE.

EGR EMT FSC GEN GPS GRD

GLOBAL POSITIONING SYSTEM

GROUND

FLEXIBLE STEEL CONDUIT ELECTRIC METALLIC TUBING EXTERNAL GROUND RING

GENERATOR

IGB IGR KW NEC PCS PH

PERSONAL NATIONAL

ELECTRIC CODE COMMUNICATION

KILOWATTS INTERIOR GROUND ISOLATED GROUND BAR DISC

CKT

CIRCUIT CONDUIT BREAKER

CONDUIT ROUTES ARE SCHEMATIC. CONTRACTOR SHALL FIELD VERIFY ROUTES BEFORE BID. ROUTE WITH WIRELESS CARRIER AND/OR BUILDING OWNER. COORDINATE

- 1. CONCEALED CONDUIT IN WALLS OR INTERIOR SPACES ABOVE GRADE MAY BE EMT OR PVC.
- CONDUIT RUNS SHALL USE APPROVED COUPLINGS AND CONNECTORS. PROVIDE INSULATED BUSHING FOR ALL CONDUIT TERMINATIONS. CONDUIT RUNS IN A WET LOCATION SHALL HAVE WATERPROOF FITTINGS.
- PROVIDE SUPPORTS FOR CONDUITS IN ACCORDANCE WITH NEC REQUIREMENTS. BE SIZED AS REQUIRED BY NEC. CONDUITS SHALL

- 1. DISCONNECT SWITCHES SHALL BE SERVICE ENTRANCE RATED, HEAVY DUTY TYPE.
- 5 CONTRACTOR SHALL VERIFY MAXIMUM AVAILABLE FAULT CURRENT AND COORDINATE INSTALLATION WITH THE LOCAL UTILITY BEFORE STARTING WORK. CONTRACTOR WILL VERIFY THAT EXISTING CIRCUIT BREAKERS ARE RATED FOR MORE THAN AVAILABLE FAULT CURRENT AND REPLACE AS NECESSARY.
- NEW CIRCUIT BREAKERS SHALL BE RATED TO WITHSTAND THE MAXIMUM AVAILABLE FAULT CURRENT AS DETERMINED BY THE LOCAL UTILITY.

CONDUCTORS:

- 1. FURNISH AND INSTALL CONDUCTORS SPECIFIED IN THE DRAWINGS. CONDUCTORS SHALL HAVE TYPE THWN (MIN) (75°C) INSULATION, RATED FOR 600 VOLTS. COPPER AND SHALL
- THE USE OF ALUMINUM CONDUCTORS SHALL BE LIMITED TO THE SERVICE FEEDERS INSTALLED BY THE UTILITY.
- CONDUCTORS SHALL BE PROVIDED AND INSTALLED AS FOLLOWS:

Ņ

- ₽ MINIMUM WIRE SIZE SHALL BE #12 AWG.
- CONDUCTORS SIZE #8 AND LARGER SHALL MAY BE SOLID OR STRANDED. BE STRANDED. CONDUCTORS SIZED #10 AND #12
- CONNECTION FOR #10 AWG #12 AWG SHALL BE BY TWISTING TIGHT AND INSTALLING INSULATED PRESSURE OR WIRE NUT CONNECTIONS.

Ċ

œ

- CONNECTION FOR #8 AWG AND LARGER SHALL NYLON INSULATOR. 쁌 BY USE OF STEEL CRIMF -ON SLEEVES WITH
- CONDUCTORS SHALL BE COLOR CODED IN ACCORDANCE WITH NEC STANDARDS.

UL COMPLIANCE:

1. ELECTRICAL MATERIALS, DEVICES, CONDUCTORS, APPLIANCES, AND EQUIPMENT SHALL BE LAOR ACCEPTED BY JURISDICTION (I.E., LOCAL COUNTY OR STATE) APPROVED THIRD PAR ABELED/LISTED BY UL

GROUNDING:

- 1. ELECTRICAL NEUTRALS, RACEWAYS AND NON-CURRENT CARRYING PARTS OF ELECTRICAL EQUIPMENT AND ASSOCIATED ENCLOSURES SHALL BE GROUNDED IN ACCORDANCE WITH NEC ARTICLE 250. THIS SHALL INCLUDE NEUTRAL CONDUCTORS, CONDUITS, SUPPORTS, CABINETS, BOXES, GROUND BUSSES, ETC. THE NEUTRAL CONDUCTOR FOR EACH SYSTEM SHALL BE GROUNDED AT A SINGLE POINT.
- PROVIDE GROUND CONDUCTOR IN RACEWAYS PER NEC.
- PROVIDE BONDING AND GROUND TO MEET NFPA 780 "LIGHTNING PROTECTION" AS A MINIMUM.
- PROVIDE GROUNDING SYSTEM AS INDICATED ON THE DRAWINGS, AS REQUIRED BY THE CODE, RADIO EQUIPMENT MANUFACTURERS, AND MOTOROLA R56 (AS APPLICABLE). NATIONAL ELECTRIC

ABBREVIATIONS AND LEGEND

DISCONNECT BELOW FINISHED GRADE BARE COPPER WIRE AMERICAN WIRE GAUGE AUTOMATIC TRANSFER SWITCH ABOVE FINISHED GRADE XM TR XFMR TGB WS PNLBD UNDERWRITERS LABORATORIES WATTS RIGID GALVANIZED RIGID NON-METALLIC CONDUIT PANELBOARD TOWER GROUND BAF TRANSMITTER VOLTAGE TRANSFORMER TEEL CONDUIT

BCW

AWG

BKR BFG

RING (HALO) SYSTEM þ \boxtimes Ø UNDERGROUND KILOWATT-HOUR METER UNDERGROUND GROUND ROD WI CADWELD UNDERGROUND BONDING AND GROUNDING CONDUCTOR. ELECTRICAL CONDUIT TELEPHONE CONDUIT 'H INSPECTION WELL



800 CORNERSTONE DRIVE KNOXVILLE, TN 37932 (865) 777-8054


INFORMATION:

LINCOLN PARK SITE #: 589403

MCNALLY ROAD (E911 ADDRESS T.B.D.) PITTSBURG, KS 66762

CRAWFORD COUNTY)

PLANS PREPARED BY:

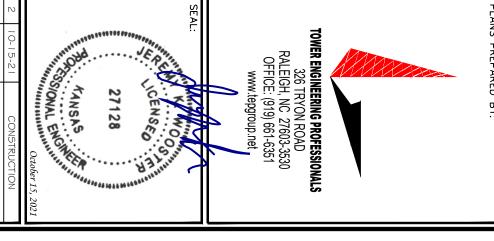

_	_				
	REV	0	1	2	
DRAWN BY:	DATE	05-17-21	08-10-21	10-15-21	
GIB CHECKED BY: KW	ISSUED FOR:	PRELIMINARY	PRELIMINARY	CONSTRUCTION	

NOTES	ELECTRICAL	
	_	

SHEET TITLE:

NOTES	ELECTRIC/
S	CAL

SHEET NUMBER

NOTES:

- FOR COMPLETE INTERNAL WIRING EQUIPMENT MANUFACTURER. AND ARRANGEMENT, REFER TO VENDOR PRINTS PROVIDED ВΥ
- 2. 200A RATED DISCONNECT FUSED AT 200A. DISCONNECT FUSED AT 200A. IF NOT EXISTING, INSTALL 200A SERVICE ENTRANCE RATED
- 3. SOME BREAKERS NOT SHOWN IN ONE LINE DIAGRAM FOR CLARITY.
- 4. CONTRACTOR TO VERIFY LOAD CENTER PANEL CAPACITY AND EXISTING LOADING IS WITHIN RATED LIMITS.
- 5. PROPOSED CONDUCTOR FEEDING PROPOSED SPECIFICATIONS. CHARLES CABINET S BASED 9 MANUFACTURER
- THE GROUNDING ELECTRODE CONDUCTOR IS SIZED FOR A SINGLE 200A SERVICE. THE CONTRACTOR INSTALL (1) 3/0 COPPER GEC INSTEAD IF THE METER BANK SHARES A COMMON N-G BOND WILL
- 7. THE WRING DIAGRAM PROVIDED BY THE MANUFACTURER DOES NOT SHOW A NEUTRAL BEING USED. THE CONTRACTOR WILL NEED TO VERIFY WITH THE INSTALLATION SPECS.

PLANS PREPARED BY:

MCNALLY ROAD
(E911 ADDRESS T.B.D.)
PITTSBURG, KS 66762
(CRAWFORD COUNTY)

					VOLT AMPS	ı	I		I	יירט ווו ובוי ט/ ד	BECTIFIER 3/A		BECTIFIED 1/2	FLOOD LIGHTS	GFCI RECEPTACLE	30766 3077763307			LOAD SERVED	
				[1	5,940		ı		ı		2880		2880		180		0	L1	VOLT AMPERES (WATTS)	
				L1 VOLT AMPERES	6,060	ı		_		2880		2880		300		0		L2	MPERES TTS)	
				MPERES		ı	l		I	(۲ ۲ ۲	7	۲ O ۷	20A	20A	OOA	6 >		TRIP	
				13,340		23	21	19	17	15 >-	13	11	9	7	5	_3		#	CKT	
	138.5	110.8	26,600				>	5	>	5	>	_ 	 	_ 	→		→		PHASE	
				13,260		24	22	20	18	16	14	12	10	8	6	4	2	#	Q K T	
•	AMPS X 125%	TOTAL AMPS	TOTAL	L2 VOL		ı	I	I	1	1	15A	-	1 7	C C	۷ 0 ک	C	4 O 2		TRIP	
	(125%	AMPS	TOTAL VOLT AMPERES	L2 VOLT AMPERES	7,400		ı		ı		200		1440		2880		2880	L1	VOLT AMPERES (WATTS)	
			PERES	ES	7,200	ı		-		ı		1440		2880		2880		L2	MPERES TTS)	
					VOLT AMPS	I	I	I	ı	ı	GFCI (COMBO CABINET)		HYAC (COMBO CABINET)	יאבט ווו ובוא 7/0	8/ 2 dalalad	יאבט ווו ובוא ט/ס	פרסדורופט ג /ג		LOAD SERVED	

TOWER ENGINEERING PROFESSIONALS

326 TRYON ROAD RALEIGH, NC 27603-3530 OFFICE: (919) 661-6351

www.tepgroup.net

PROP. #4
GROUNDING
ELECTRODE
CONDUCTOR.
SEE NOTE 6.-

PROP. $2\frac{1}{2}$ " C. W/ (3)-3/0-

 \leq

SEE NOTE 2.

PROPOSED 200A METER.-

EXISTING INCOMING SERVICE BY LOCAL UTILITY COMPANY

PROP. $2\frac{1}{2}$ " C. (3)-3/0 AND

<

(1)-#2 GND:

PROPOSED (1) ¾" C. W/ PULL STRING FOR RADIO CABINET ALARM CABLING

PROPOSED (4) 1" C. EACH W/ (3) #10 AND (1) #10 GND

PROPOSED
U.S. CELLULAR
CHARLES INDUSTRIES
COMBO CABINET

•

SIM

CONTRACTOR TO VERIFY THE SIZE OF ALL BREAKERS SHOWN AND WITH MANUFACTURER SPECIFICATIONS.

%uscellular

PREPARED FOR:

800 CORNERSTONE DRIVE KNOXVILLE, TN 37932 (865) 777-8054

LINCOLN PARK

INFORMATION:

SITE #: 589403

NOTE:

200A 120/240VAC POWER PANEL SCHE DULE

1000	Ш	1				-			֓֞֞֜֜֜֓֓֓֓֓֓֓֓֓֓֓֓֓֟֜֓֓֓֓֓֓֓֓֓֓֡֜֜֜֓֓֓֓֡֓֜֡֓֡֓֡֡֓֜֡֓֡֡֡֡֡֓֜֡֡֓֡֓֜֡֡֓֜֡֡֡֡֓֜֝֡֡֡֡֡֓֜֝֡֡֡֡֓֜֝֡֡֡֡֓֜֝֡֡֡֡֜֝֡֡֡֡֡	
LOAD SERVED	VOLT AI	VOLT AMPERES (WATTS)	TRIP	CKT Pr	PHASE	#CKT	TRIP	VOLT AMPERES (WATTS)	MPERES TS)	LOAD SERVED
	0		3		>	2		2880		
RGE VOTTREVVOR		0	O C A	۵	 	4	JOA		2880	מפרויופא ט/ס
FCI RECEPTACLE	180		20A	5	>	6	70.	2880		סרסזורורט ז /ס
FLOOD LIGHTS		300	20A	7] 	∞	JOA		2880	מבכוודובת //ס
DECTIFIED 1/2	2880		402		>	10	100	1440		HVAC (COMBO CABINET)
KECIII IEK 1/2		2880	JUA	11		12	J		1440	TIVAC (COMBO CADINEI)
DECTIFIED 3//	2880		۲ O ک	13	>	14	15A	200		GFCI (COMBO CABINET)
יאבט ווו וביא ט/ ד		2880	(15] 	16	ı		1	I
I	ı		I	17	>	18	ı	ı		I
		ı		19	<u></u>	20	ı		1	ı
I	ı		I	21	>	22	ı	ı		I
		ı			<u></u>	24	ı		ı	I
VOLT AMPS	5,940	6,060						7,400	7,200	VOLT AMPS
	[]	L1 VOLT AMPERES	MPERES	13,340	13,260	60	L2 VOL1	L2 VOLT AMPERES		
				26	26,600		TOTAL V	TOTAL VOLT AMPERES	ERES	
				<u> </u>	110.8		TOTAL AMPS	MPS		
				1.	138.5		AMPS X 125%	125%		

ONE LINE SCALE: N.T.S. DIAGRAM

60A -

SUPPRESSOR

20A

RECEPTACLE

-20A

FLOOD LIGHTS

15A

— PROPOSED (1) ¾" C. W/ (4) #12 AND (2) #12 GND FOR HVAC & GFCI

RAYCAP TYP OF 2

2)

JUNCTION BOX

PROPOSED HYBRID
TO TOWER-MOUNTED RAYCAP ---

PROPOSED EMERSON CAC

-- PROPOSED 1½" CONDUIT FOR FIBER & 1¼" CONDUIT FOR POWER TO RAYCAP (TYP PER RAYCAP)

•15A

30A

PROPOSED (1) 4" C. FOR INCOMING FIBER

-PROPOSED 2½" CONDUIT FOR FIBER & 2½" CONDUIT FOR POWER TO RAYCAP (TYP PER RAYCAP)

30A

30A

E-2

NUMBER:

ONE LINE DIAGRAM & POWER PANEL SCHEDULE

SHEET TITLE:

05-17-21


DATE


SSUED FOR: PRELIMINARY PRELIMINARY

08-10-21

KANSAS METERSONAL ENGINEERS

ANS PS

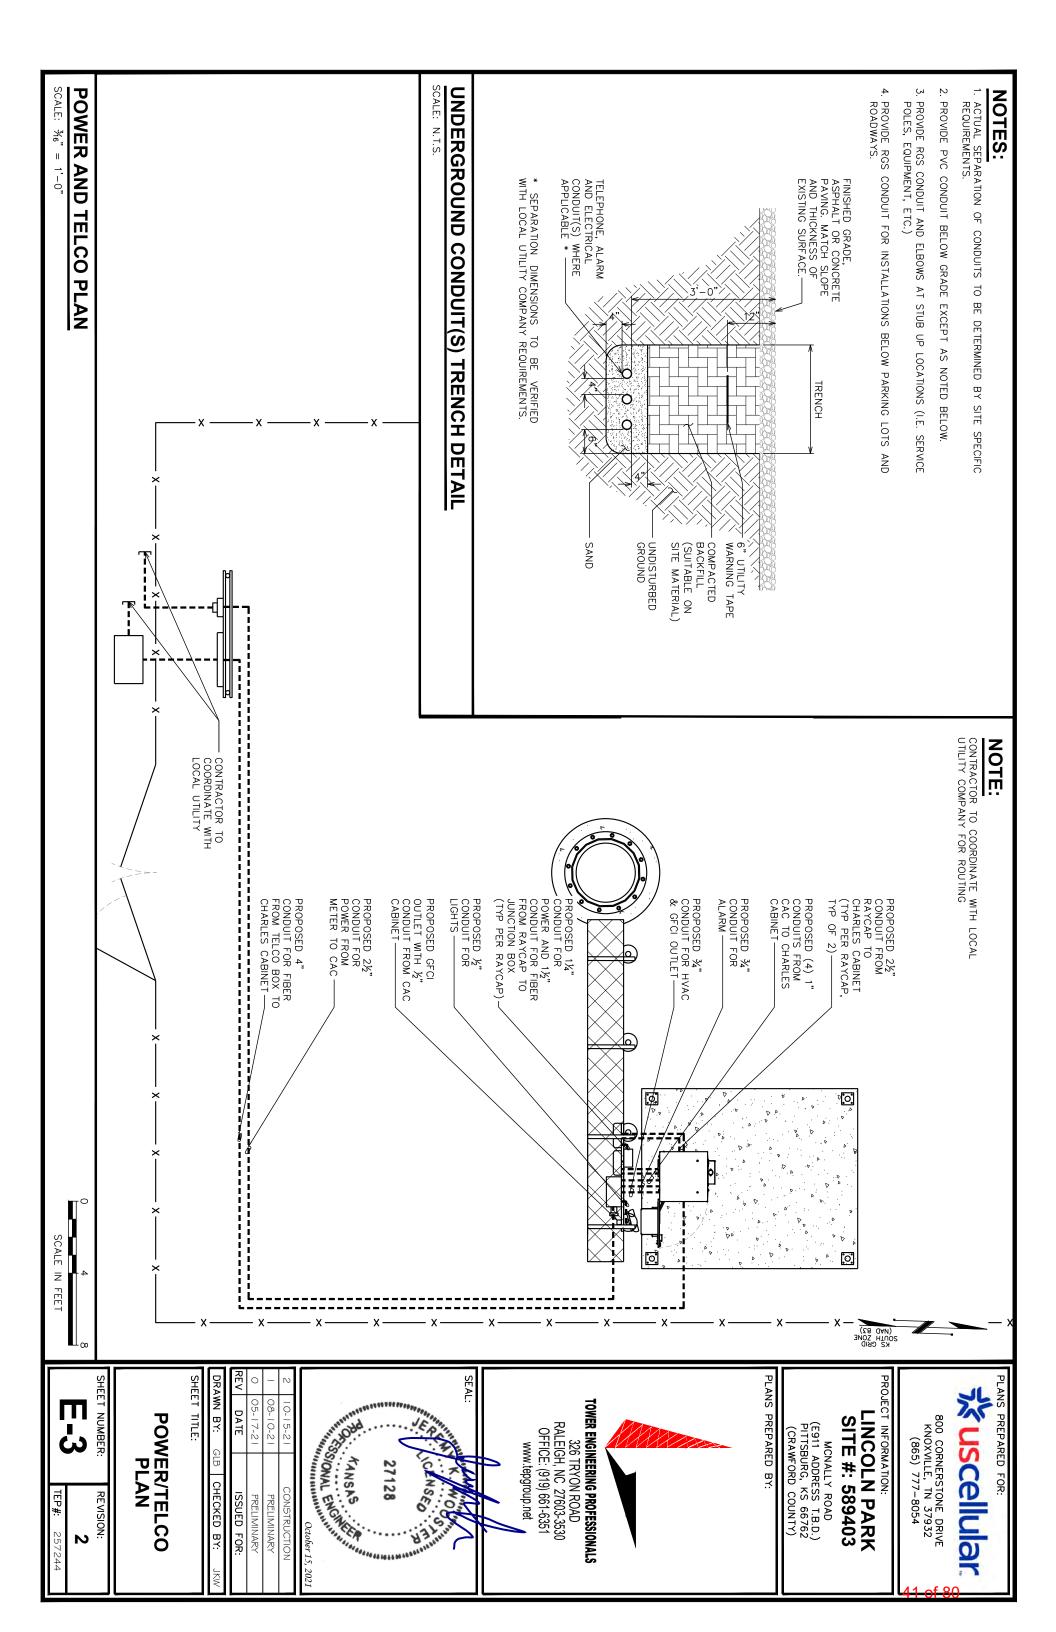

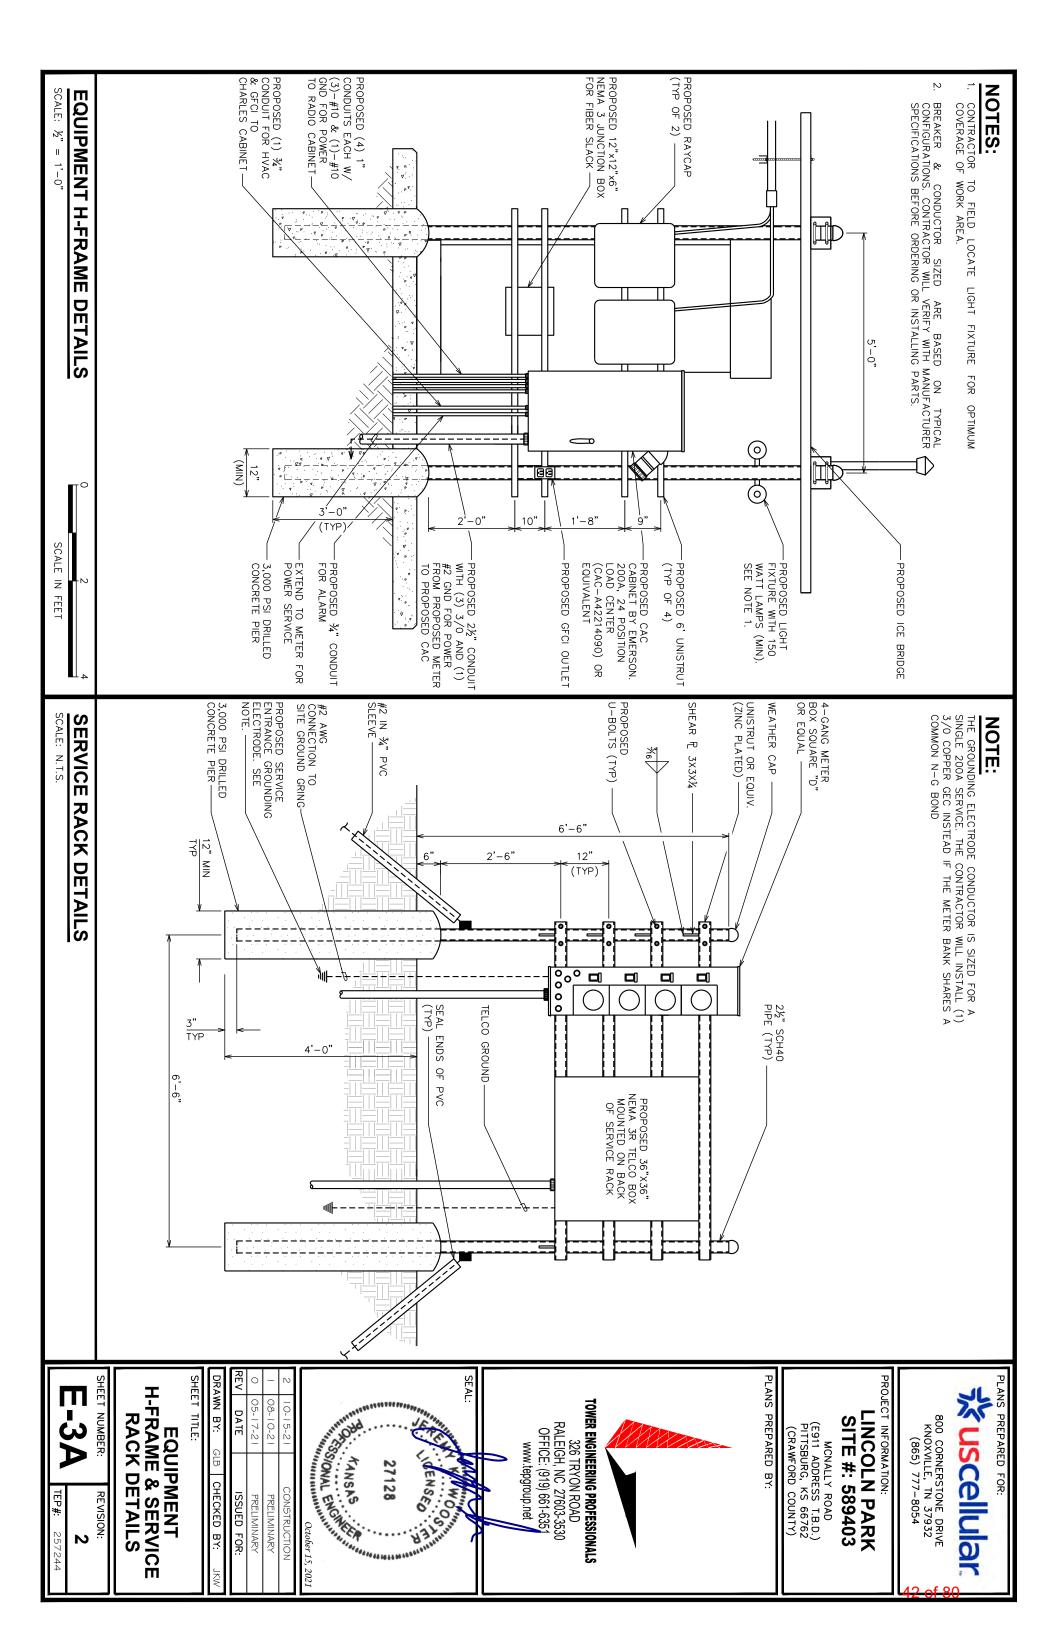

DRAWING NOTES


- PROPOSED TOWER GROUND RING BURIED 30" DEPTH (WHICHEVER IS GREATER) BFG OR 6" BELOW FROST
- ō **PROPOSED**
- PROPOSED TOWER GROUND RING BOND EQUIPMENT GROUND RING (TYP OF 2)
- PROPOSED %"øx10' COPPER GROUND ROD
- PROPOSED TOWER GROUND BAR
- 5 PROPOSED EQUIPMENT GROUND RING (BURIED FROST DEPTH, WHICHEVER IS GREATER) 30" BFG R 6" BELOW
- 6 SERVICE ENTRANCE GROUNDING ELECTRODE
- $\left(7\right)$ FOR EQUIPMENT PAD GROUNDING, SEE SHEET E-5.
- (∞) GROUND RING O TOWER STEEL (TYP 유 3)
- (0) PROPOSED GROUND ROD WITH INSPECTION WELL (TYP)
- (0) GATE POST GROUNDING (TYP)
- (=) СE BRIDGE POST GROUND TO EQUIPMENT GROUND RING
- $\begin{pmatrix} 1 \\ 2 \end{pmatrix}$
- (13) PROPOSED 2-HOLE MECHANICAL LUG (TYP)

GROUNDING NOTES:

- CONTRACTOR SHALL VERIFY THAT GROUNDING ELECTRODES SHALL BE CONNECTED IN A RING USING #2 AWG BARE TINNED COPPER WIRE. THE TOP OF THE GROUND RODS AND THE RING CONDUCTOR SHALL BE 30 INCHES BELOW FINISHED GRADE OR 6" BELOW FROST DEPTH (WHICHEVER IS GREATER). GROUNDING ELECTRODES SHALL BE DRIVEN ON 10'-0" CENTERS (9'-0" MINIMUM, 16'-0" MAXIMUM; PROVIDE AND INSTALL AS REQUIRED PER TYPICAL GROUNDING PLAN SHOWN).
- Ņ BONDING OF THE GROUNDED CONDUCTOR (NEUTRAL) AND THE GROUNDING SHALL BE AT THE SERVICE DISCONNECTING MEANS. BONDING JUMPER INSTALLED PER N.E.C. ARTICLE 250.30. CONDUCTOR SHALL BE
- Ņ GROUND RING CONNECTION CONDUCTORS SHALL BONDING TECHNIQUE. BE OF EQUAL LENGTH, MATERIAL, AND
- CONTRACTOR SHALL ENSURE GROUND RING IS WITHIN 12 TO 36 INCHES OF THE EQUIPMENT PAD. PROVIDE/INSTALL GROUNDING CONNECTIONS SHOWN ABOVE AS NEEDED PER EXISTING SITE GROUNDING SYSTEM. CONTRACTOR SHALL VERIFY ALL EXISTING SITE GROUNDING SYSTEM ON THE CONTRACTOR SHALL VERIFY ALL EXISTING SITE GROUNDING CONDITIONS BEFORE STARTING WORK OR PURCHASING EQUIPMENT.

4.

- Ù BOND CIGBE TO EXTERNAL GROUND RING WITH 2 RUNS COPPER CONDUCTOR IN PVC. CONNECT BAR END WITH 2 THE OTHER END TO THE EXTERNAL GROUND ROD. OF #2 BARE TINNED SOLID HOLE LUG, AND "CADWELD"
- 6 THE PREFERRED LOCATION FOR COAX GROUNDING IS AT THE BASE OF THE TOWER PRIOR TO THE COAX BEND. BONDING IS SHOWN ON THE ICE BRIDGE DUE TO DIFFICULTY WITH WELDING OR ATTACHING TO TOWER LEGS. CONTRACTOR SHALL ADVISE CONSTRUCTION MANAGER PRIOR TO PLACING CIGBE ON ICE BRIDGE IF MOUNTING TO TOWER LEG IS POSSIBLE.

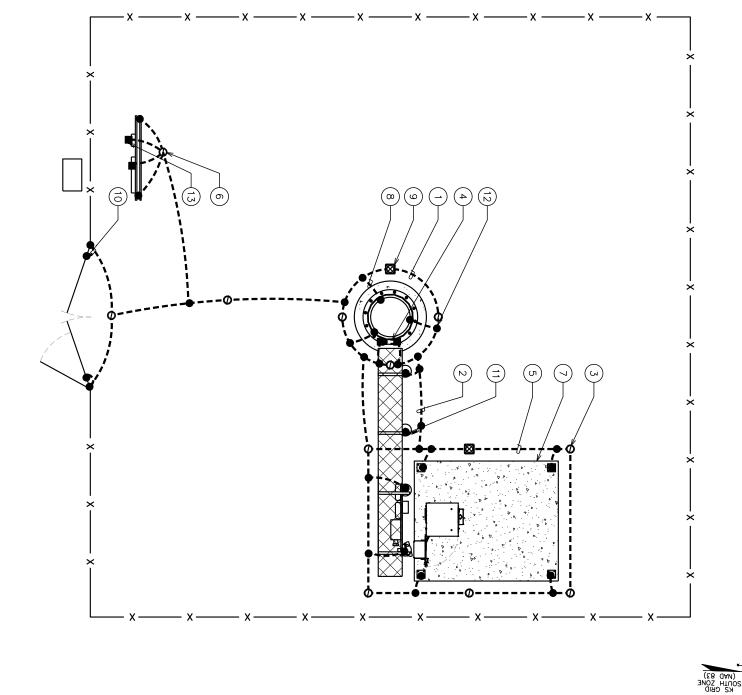

TOWER ENGINEERING PROFESSIONALS

326 TRYON ROAD RALEIGH, NC 27603-3530 OFFICE: (919) 661-6351

www.tepgroup.net



800 CORNERSTONE DRIVE KNOXVILLE, TN 37932 (865) 777-8054

INFORMATION:

LINCOLN PARK SITE #: 589403

MCNALLY ROAD
(E911 ADDRESS T.B.D.)
PITTSBURG, KS 66762
(CRAWFORD COUNTY)

PLANS PREPARED BY:

TANSAS METERSIONAL ENGINEERS ANS PS ... ANS PS ...

ISSUED FOR:	DATE	REV
PRELIMINARY	05-17-21	0
PRELIMINARY	08-10-21	1
CONSTRUCTION	10-15-21	2

SHEET TITLE:

COMPOUND GROUNDING PLAN

SHEET NUMBER REVISION:

E-4 N

COMPOUND GROUNDING PLAN


SCALE IN FEET


DRAWING NOTES

- EXTEND EQUIPMENT GROUND RING TO PROPOSED TOWER GROUND RING
- (2) PROPOSED %" 0x10' COPPER GROUND ROD (TYP)
- (3) PROPOSED EQUIPMENT GROUND RING (BURIED 30" FROST DEPTH, WHICHEVER IS DEEPER) BFG R ರ್ತ
- GROUND PROPOSED CABINET PER MFG'S SPECIFICATIONS
- CABINET GROUND TO PROPOSED GROUND RING
- 6 GROUND BAR MOUNTED ON H-FRAME
- 7 GROUND LEAD FROM PROPOSED GROUND BAR TO PROPOSED GROUND RING (TYP OF 2)
- (∞) PROPOSED EQUIPMENT GROUND (TYP)
- 9 PROPOSED CADWELD (TYP)
- PROPOSED 2-HOLE MECHANICAL LUG (TYP)
- (= PROPOSED GROUND ROD WITH INSPECTION WELL

GROUNDING NOTES:

- CONTRACTOR SHALL VERIFY THAT GROUNDING ELECTRODES SHALL CONNECTED IN A RING USING #2 AWG BARE TINNED COPPER WIRE. TOP OF THE GROUND RODS AND THE RING CONDUCTOR SHALL BE INCHES BELOW FINISHED GRADE. GROUNDING ELECTRODES SHALL DRIVEN ON 10'-0" CENTERS (9'-0" MINIMUM, 16'-0" MAXIMUM; PROV AND INSTALL AS REQUIRED PER TYPICAL GROUNDING PLAN SHOWN). HALL BE //RE. THE L BE 30 HALL BE PROVIDE
- 5 BONDING OF THE GROUNDED CONDUCTOR (NEUTRAL) AND THE GROUNDING CONDUCTOR SHALL BE AT THE SERVICE DISCONNECTING MEANS. BONDING JUMPER SHALL BE INSTALLED PER N.E.C. ARTICLE 250.30.
- GROUND RING CONNECTION CONDUCTORS SHALL BE OF EQUAL LENGTH, MATERIAL, AND BONDING TECHNIQUE.
- CONTRACTOR SHALL ENSURE GROUND RING IS WITHIN 12 TO 36 INCHES OF THE EQUIPMENT PAD. PROVIDE/INSTALL GROUNDING CONNECTIONS SHOWN ABOVE AS NEEDED PER EXISTING SITE GROUNDING SYSTEM. CONTRACTOR SHALL VERIFY ALL EXISTING SITE GROUNDING CONDITIONS BEFORE STARTING WORK OR PURCHASING EQUIPMENT.
- ù BOND CIGBE TO EXTERNAL GROUND RING WITH 2 RUNS OF #2 BARE TINNED SOLID COPPER CONDUCTOR IN PVC. CONNECT BAR END WITH 2 HOLE LUG, AND "CADWELD" THE OTHER END TO THE EXTERNAL GROUND ROD.
- 6. THE PREFERRED LOCATION FOR COAX GROUNDING IS AT THE BASE OF THE TOWER PRIOR TO THE COAX BEND. BONDING IS SHOWN ON THE ICE BRIDGE DUE TO DIFFICULTY WITH WELDING OR ATTACHING TO TOWER LEGS. CONTRACTOR SHALL ADVISE CONSTRUCTION MANAGER PRIOR TO PLACING CIGBE ON ICE BRIDGE IF MOUNTING TO TOWER LEG IS POSSIBLE.

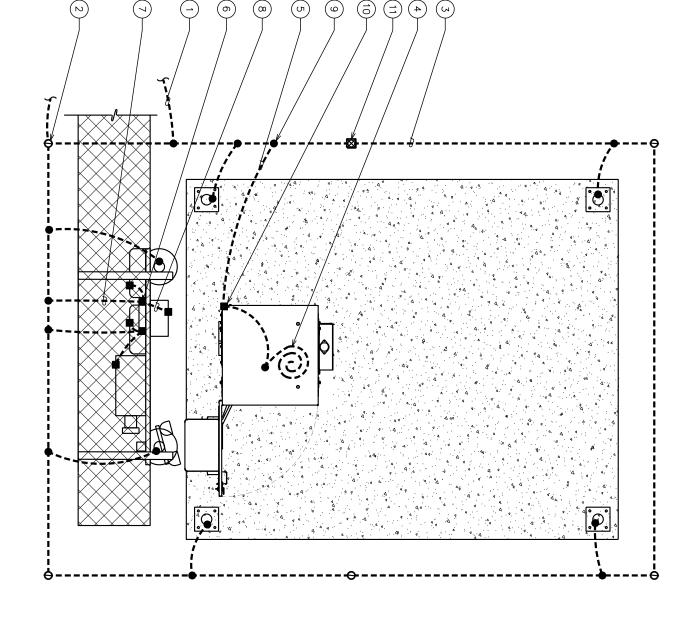

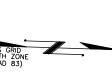



INFORMATION:

LINCOLN PARK SITE #: 589403

MCNALLY ROAD
(E911 ADDRESS T.B.D.)
PITTSBURG, KS 66762
(CRAWFORD COUNTY)

PLANS PREPARED BY:

EQUIPMENT GROUNDING PLAN

0 05-17-21

DATE


SSUED FOR: PRELIMINARY


SHEET TITLE:


SHEET NUMBER E-5 REVISION: N

TYPICAL

SCALE IN FEET

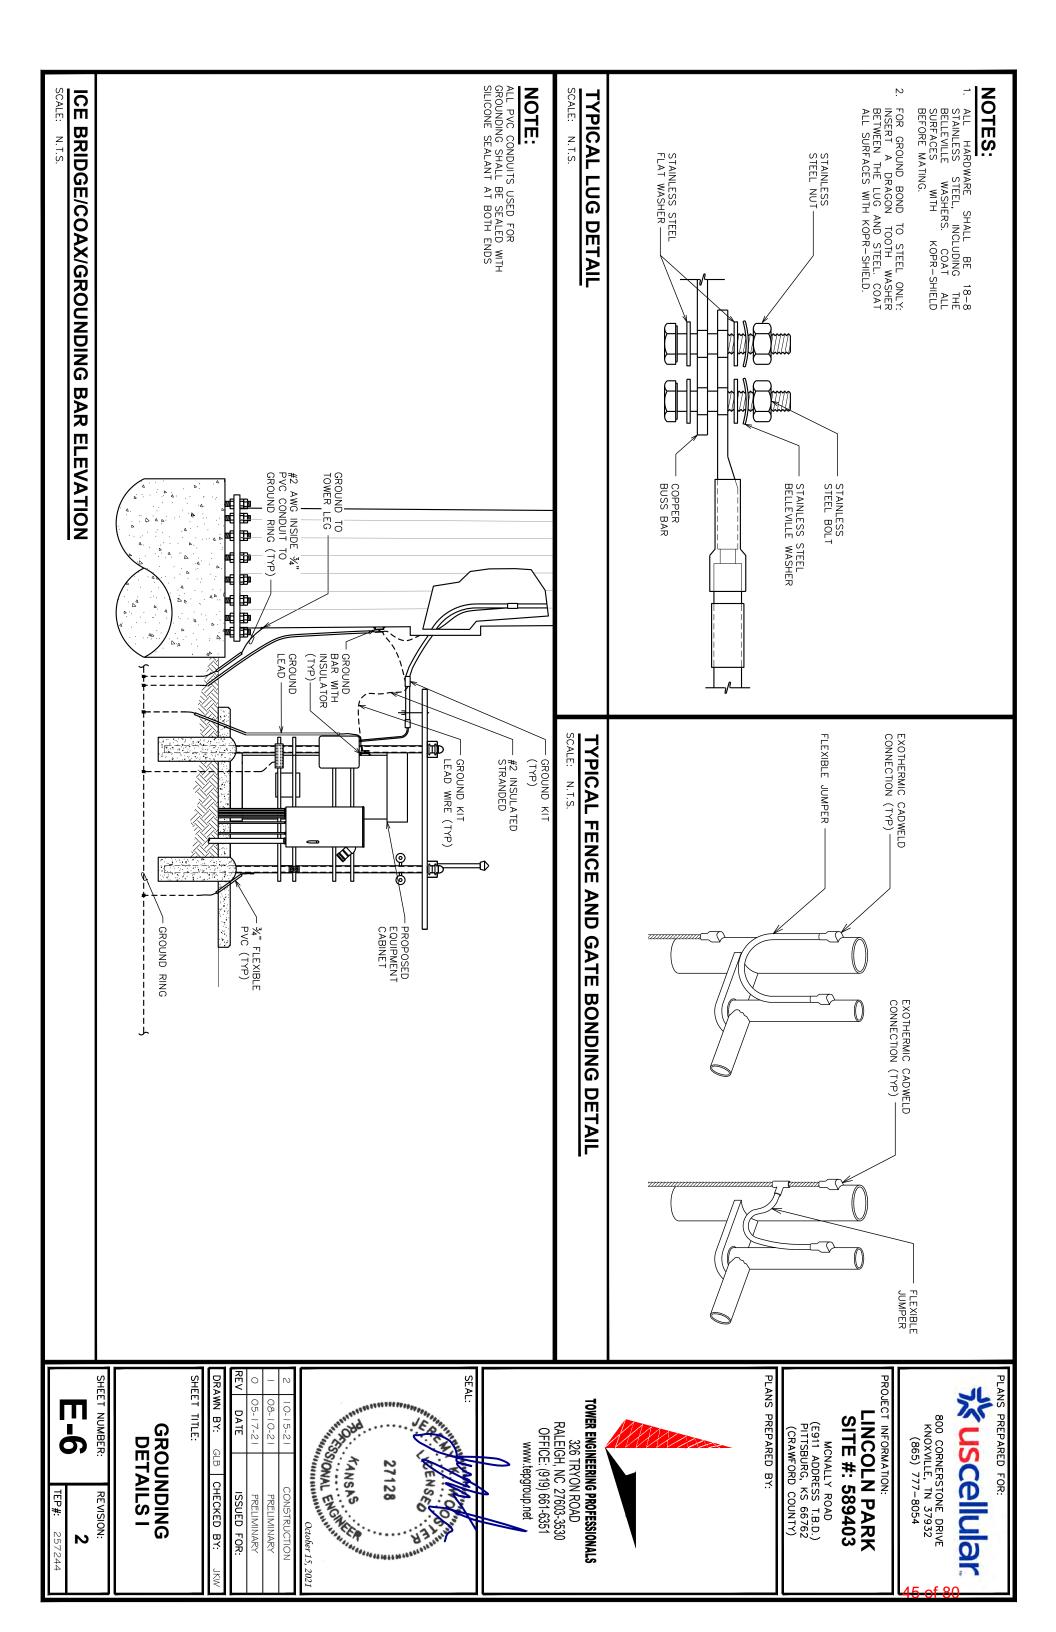

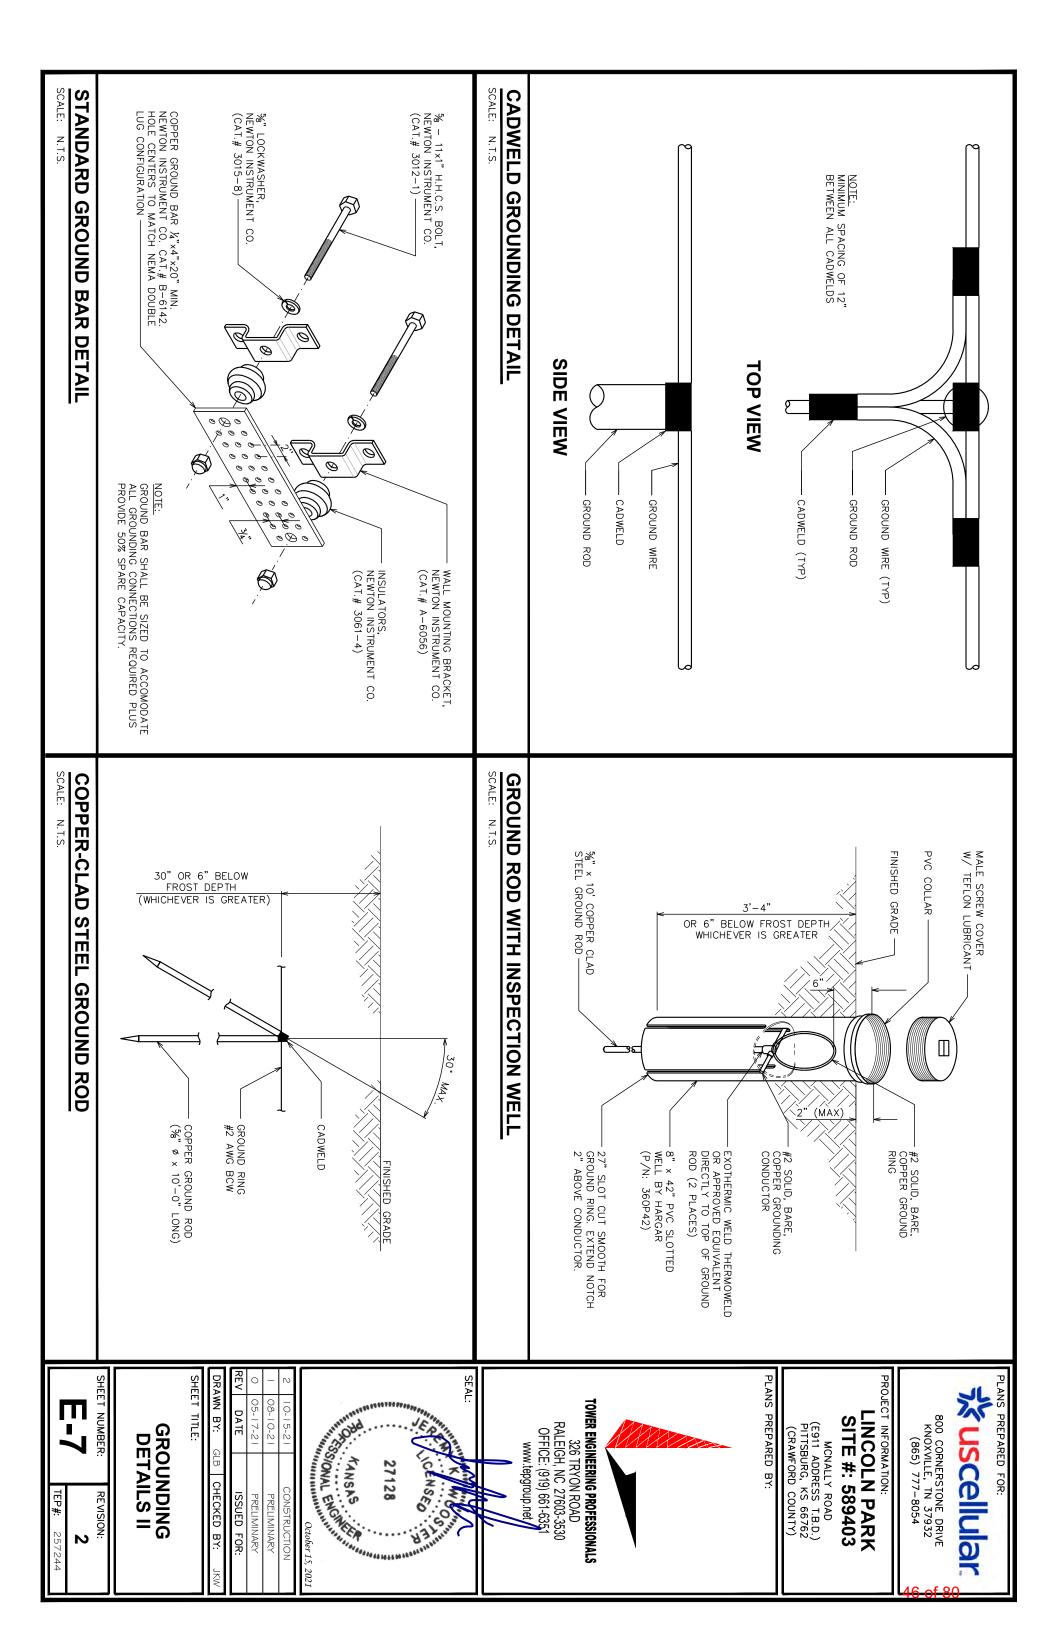

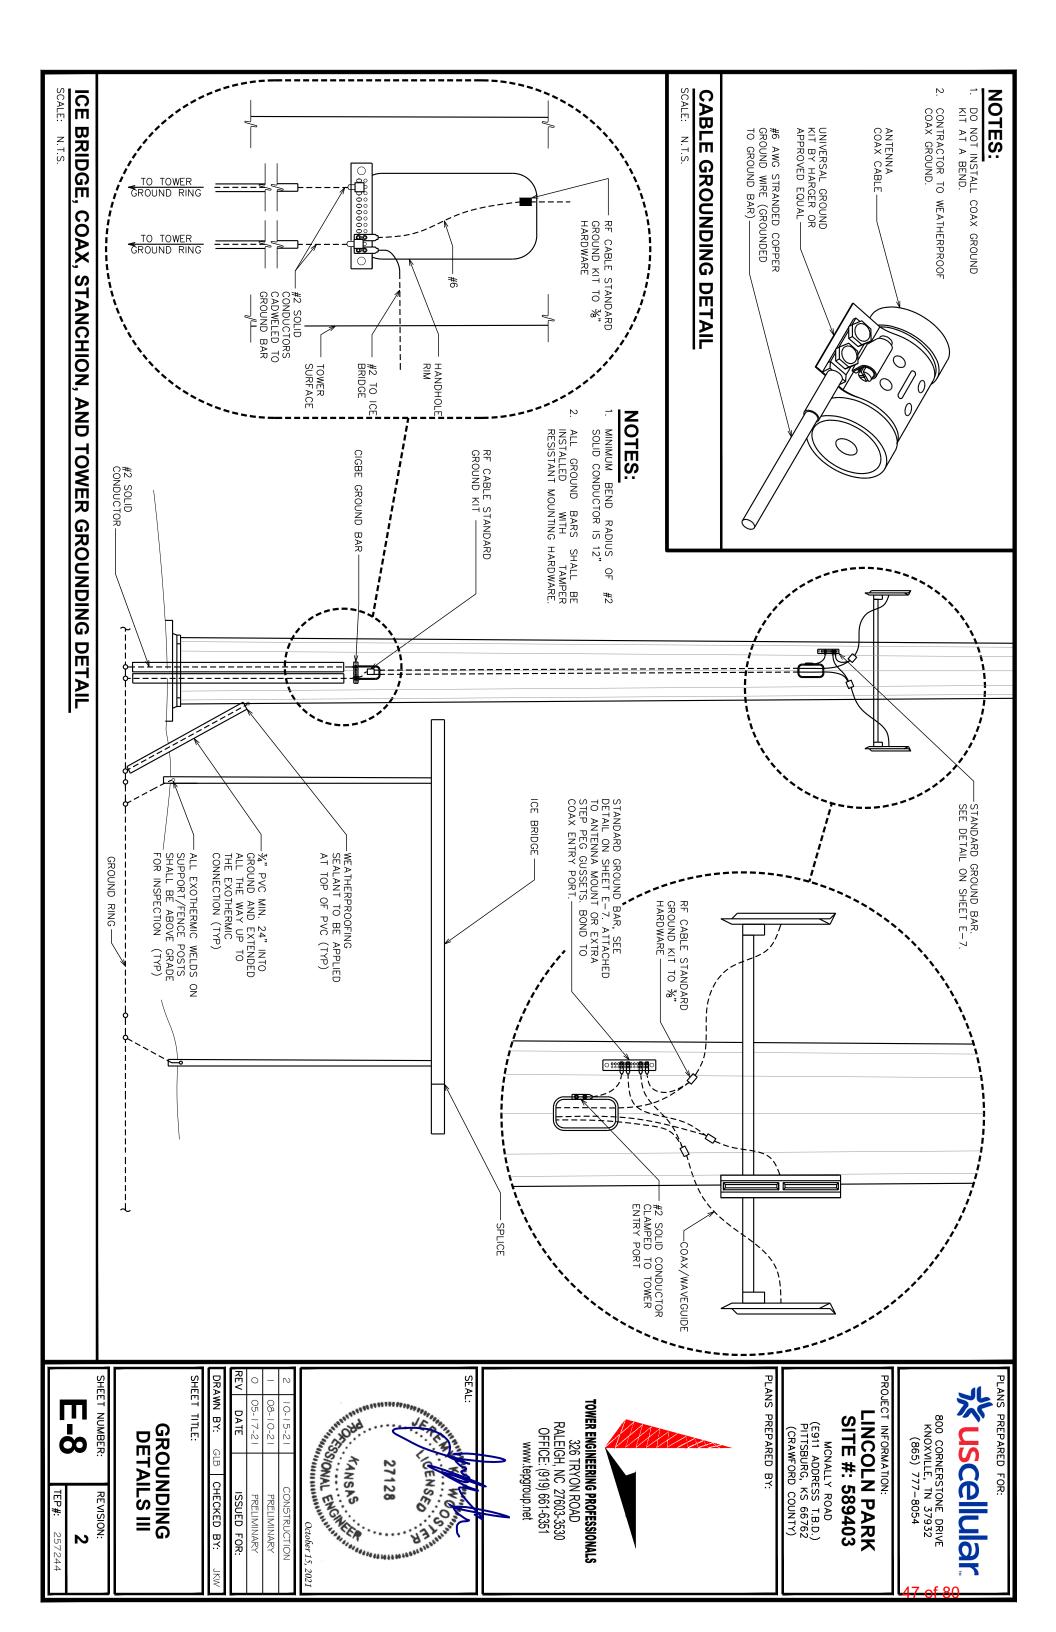

G Ш **NERAL NOTE**

- ALL REFERENCES REPRESENTATIVE. O OWNER IN **JASSE** DOCUMENTS SHALL 먪 CONSIDERED ∪.S. CELLULAR 유 STI DESIGNATED
- ALL WORK PRESENTED ON THESE DRAWINGS MUST BE COMPLETED BY THE CONTRACTOR UNLESS NOTED OTHERWISE. THE CONTRACTOR MUST HAVE CONSIDERABLE EXPERIENCE IN PERFORMANCE OF WORK SIMILAR TO THAT DESCRIBED HEREIN. BY ACCEPTANCE OF THIS ASSIGNMENT, THE CONTRACTOR IS ATTESTING THAT HE DOES HAVE SUFFICIENT EXPERIENCE AND ABILITY, THAT HE IS KNOWLEDGABLE OF THE WORK TO BE PERFORMED AND THAT HE IS PROPERLY LICENSED AND PROPERLY REGISTERED TO DO THIS WORK IN THE STATE OF KANSAS.
- STRUCTURE IS DESIGNED IN ACCORDANCE WITH ANSI/TIA/EIA-222-H, 2009, AND CONFORMS TO OF THE KANSAS BUILDING CODE, 2018 EDITION. THE REQUIREMENTS
- 4. Z ACCORDANCE ¥∃H Ħ KANSAS BUILDING CODE, 2018 EDITION.
- Ċ٦ UNLESS SHOW NMOHS IN OR NOTED OTHERWISE ON THE APPLY TO THE MATERIALS LISTED CONTRACT DRAWINGS, OR IN THE SPECIFICATIONS, THE FOLLOWING HEREIN, AND TO THE PROCEDURES TO BE USED ON THIS PROJECT.
- 6 ALL HARDWARE ASSEMBLY MANUFACTURER'S CONFLICTING NOTES ENCLOSED HEREIN. INSTRUCTIONS SHALL BE FOLLOWED EXACTLY AND SHALL SUPERSEDE ANY
- .7 IT IS THE SAFETY OF BUT IS NO MATERIAL THE PROJE HE CONTRACTOR'S SOLE RESPONSIBILITY TO DETERMINE ERECTION PROCEDURE AND SEQUENCE, TO INSURE THE OF THE STRUCTURE AND ITS COMPONENT PARTS DURING ERECTION AND/OR FIELD MODIFICATIONS. THIS INCLUDES, NOT LIMITED TO, THE ADDITION OF TEMPORARY BRACING, GUYS OR TIE DOWNS THAT MAY BE NECESSARY. SUCH ALL SHALL BE REMOVED AND SHALL REMAIN THE PROPERTY OF THE CONTRACTOR AFTER THE COMPLETION OF
- œ ALL DIMENSIONS, ELEVATIONS, AND EXISTING CONDITIONS SHOWN ON THE DRAWINGS SHALL BE FIELD VERIFIED BY THE CONTRACTOR PRIOR TO BEGINNING ANY MATERIALS ORDERING, FABRICATION OR CONSTRUCTION WORK ON THIS PROJECT. CONTRACTOR SHALL NOT SCALE CONTRACT DRAWINGS IN LIEU OF FIELD VERIFICATIONS. ANY DISCREPANCIES SHALL BE IMMEDIATELY BROUGHT TO THE ATTENTION OF THE OWNER AND THE OWNER'S ENGINEER. THE DISCREPANCIES MUST BE RESOLVED BEFORE THE CONTRACTOR IS TO PROCEED WITH THE WORK. THE CONTRACT DOCUMENTS DO NOT INDICATE THE METHOD OF CONSTRUCTION. THE CONTRACTOR SHALL SUPERVISE AND DIRECT THE WORK AND SHALL BE SOLELY RESPONSIBLE FOR ALL CONSTRUCTION MEANS, METHODS, TECHNIQUES, SEQUENCES, AND PROCEDURES. OBSERVATION VISITS, TO THE SITE BY THE OWNER AND/OR THE ENGINEER SHALL NOT INCLUDE INSPECTION OF THE PROTECTIVE MEASURES.
- 9 ALL MATERIALS AND EQUIPMENT FURNISHED SHALL BE NEW AND OF GOOD QUALITY, FREE FROM FAULTS AND AND IN CONFORMANCE WITH THE CONTRACT DOCUMENTS. ANY AND ALL SUBSTITUTIONS MUST BE PROPERLY A AND AUTHORIZED IN WRITING BY THE OWNER AND ENGINEER PRIOR TO INSTALLATION. THE CONTRACTOR SHALL SATISFACTORY EVIDENCE AS TO THE KIND AND QUALITY OF THE MATERIALS AND EQUIPMENT BEING SUBSTITUTE ND DEFECTS Y APPROVED ALL FURNISH
- 10. THE CONTRACTOR SHALL BE RESPONSIBLE FOR INITIATING, MAINTAINING, AND SUPERVISING ALL SAFETY PRECAUTIONS AND PROGRAMS IN CONNECTION WITH THE WORK. THE CONTRACTOR IS RESPONSIBLE FOR INSURING THAT THIS PROJECT AND RELATED WORK COMPLIES WITH ALL APPLICABLE LOCAL, STATE, AND FEDERAL SAFETY CODES AND REGULATIONS GOVERNING THIS WORK.
- ACCESS TO THE PROPOSED WORK SITE MAY E ACTIVITY, INCLUDING WORK SCHEDULE AND BE RESTRICTED. THE CONTRACTOR D MATERIALS ACCESS, WITH THE SHALL COORDINATE INTENDED CONSTRUCTION RESIDENT LEASING AGENT FOR APPROVAL.
- 12. BILL OF MATERIALS CONTRACTOR SHALL S AND PART NUMBERS LISTED VERIFY PARTS AND QUANTITIES ON CONSTRUCTION DRAWINGS WITH MANUFACTURER PRIOR TO ARE INTENDED TO AID CO BIDDING AND/OR ORDERING CONTRACTOR.
- 13. FOR PERMITS THAT MUST BE OBTAINED ARE THE RESPONSIBILITY OF THE CONTRACTOR. ABIDING BY ALL CONDITIONS AND REQUIREMENTS OF THE PERMITS. THE CONTRACTOR WILL BE RESPONSIBLE
- 4 24 HOURS PRIOR TO THE BEO BEGINNING ENGINEER. 읶 ANY CONSTRUCTION, 품 CONTRACTOR MUST NOTIFY 품 APPLICABLE JURISDICTIONAL
- <u>1</u>5. E CONTRACTOR SHALL REWORK (DRY, SCARIFY, ETC.) ALL MATERIAL NOT SUITABLE FOR SUBGRADE TER REWORKING, IF THE MATERIAL REMAINS UNSUITABLE, THE CONTRACTOR SHALL UNDERCUT THIS NIH APPROVED MATERIAL. ALL SUBGRADES SHALL BE PROOFROLLED WITH A FULLY LOADED TANDEM AND PAVING. ANY SOFTER MATERIAL SHALL BE REWORKED OR REPLACED. E IN ITS PRESENT STATE.

 S MATERIAL AND REPLACE

 AXLE DUMP TRUCK PRIOR
- CONTRACTOR IS REQUIRED TO MAINTAIN ALL PIPES, DITCHES, TIL WORK IS ACCEPTED BY THE OWNER. THE CONTRACTOR MAINTAIN DRAINAGE STRUCTURE IN OPERABLE CONDITION. AND OTHER DRAINAGE IS RESPONSIBLE FOR STRUCTURES FREE FROM ANY DAMAGES CAUSED OBSTRUCTION

 BY FAILURE
- 17. ALL MATERIALS AND WORKMANSHIP SHALL BE WARRANTED FOR ONE YEAR FROM
- <u>,</u> ALL BUILDING DIMENSIONS SHALL BE VERIFIED WITH THE PLANS (LATEST REVISION) PRIOR TO COMMENCING CONSTRUCTION. NOTIFY THE ENGINEER IMMEDIATELY IF ANY DESCREPANCEIES ARE DISCOVERED. THE OWNER SHALL HAVE A SET OF APPROVED PLANS AVAILABLE AT THE SITE AT ALL TIMES WHILE WORK IS BEING PERFORMED. A DESIGNATED RESPONSIBLE EMPLOYEE SHALL BE AVAILABLE FOR CONTACT BY GOVERNING AGENCY INSPECTORS.

S TRUCTURAL S шi Ш NOTE

- FABRICATION AND ERECTION OF STRUCTURAL STEEL MANUAL OF STEEL CONSTRUCTION, 14TH EDITION. SHALL CONFORM TO THE AISC SPECIFICATIONS
- UNLESS OTHERWISE NOTED, ALL STRUCTURAL ELEMENTS SHALL CONFORM TO A. STRUCTURAL STEEL, ASTM DESIGNATION A36 OR A992-GR50.

 B. ALL BOLTS, ASTM A325 TYPE I GALVANIZED HIGH STRENGTH C. ALL NUTS, ASTM A563 CARBON AND ALLOY STEEL NUTS.

 D. ALL WASHERS, ASTM F436 HARDENED STEEL WASHERS. FOLLOWING REQUIREMENTS:

'n

- М ΣF L CONNECTIONS NOT FULLY DETAILED ON THESE PLANS SHALL BE DETAILED BY THE STEEL FABRICATOR ACCORDANCE WITH AISC SPECIFICATIONS AND MANUAL OF STEEL CONSTRUCTION, 14TH EDITION.
- HOLES SHALL NOT CUT THRU STEEL UNLESS APPROVED BY THE ENGINEER.
- GALVANIZING: HOT-DIP GALVANIZE ALL ITEMS UNLESS OIHEK ZING: ASTM A123, ASTM, A153/A153M OTHERWISE 유 ASTM A653/A653M, G90, NOTED, **AFTER** FABRICATION WHERE PRACTICABLE. 53M, G90, AS APPLICABLE.

Ò 4.

- <u></u>6 REPAIR DAMAGED SURFACES WITH GALVANIZING REPAIR METHOD AND PAINT CONFORMING TO ASTM A780 OR BY APPLICATION OF STICK OR THICK PASTED MATERIAL SPECIFICALLY DESIGNED FOR REPAIR OF GALVANIZING. CLEAN AREAS TO BE REPAIRED AND REMOVE SLAG FROM WELDS. HEAT SURFACES TO WHICH STICK OR PASTE MATERIAL IS APPLIED, WITH A TORCH TO A TEMPERATURE SUFFICIENT TO MELT THE METALLICS IN STICK OR PASTE; SPREAD MOLTEN MATERIAL UNIFORMLY OVER SURFACES TO BE COATED AND WIPE OFF ANY EXCESS.
- A NUT LOCKING DEVICE SHALL BE INSTALLED ON ALL PROPOSED AND/OR REPLACED BOLTS.
- œ PROPOSED AND/OR REPLACED M THE SHEAR PLANE. BOLTS SHALL 略 읶 SUFFICIENT LENGTH TO EXCLUDE THE THREADS
- 9 ALL PROPOSED AND/OR REPLACED BOLTS SHALL BE OF SUFFICIENT LENGTH BOLT BE AT LEAST FLUSH WITH THE FACE OF THE NUT. IT IS NOT PER TO BE BELOW THE FACE OF THE NUT AFTER TIGHTENING IS COMPLETED. S CH THAT THE END OF THE
- <u>,</u> ALL ASSEMBLY AND ANCHOR BOLTS ARE TO BE TIGHTENED TO A "SNUG T IN SECTION 8.1 OF THE AISC, "SPECIFICATION FOR STRUCTURAL JOINTS BOLTS", DATED JUNE 30, 2004. TIGH 'IGHT" CONDITION AS DEFINED USING ASTM A325 OR A490
- ARE TO BE INSTALLED W.TH BOLTS
- 12. AS AS NOT OVER TORQUE ASSEMBLY BOLTS. GALVANIZING ON A LUBRICANT, THUS OVER TIGHTENING MAY OCCUR AND M N BOLTS, NUTS, AN MAY CAUSE BOLTS D STEEL PARTS MAY ACT TO CRACK AND SNAP OFF.
- 13. NUTS ARE REQUIRED W TO BE INSTALLED AFTER NUTS WHEN SELF-LOCKING NUTS ARE F MTH LIP OUT. PAL NUTS ARE
- 14. GALVANIZED ASTM BOL TS SHALL NOT BE

5

ACCORDANCE WITH AMERICAN SOCIETY (AWS) D1.1-2010




800 CORNERSTONE DRIVE KNOXVILLE, TN 37932 (865) 777-8054


PROJECT INFORMATION: LINCOLN PARK

SITE #: 589403 MCNALLY ROAD (E911 ADDRESS T.B.D.) PITTSBURG, KS 66762

CRAWFORD COUNTY)

PLANS PREPARED BY:

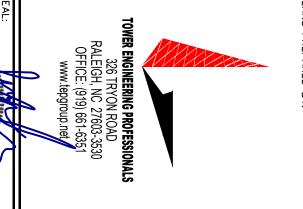

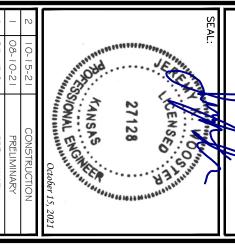

ISSUED FOR:	DATE	REV
PRELIMINARY	05-17-21	0
PRELIMINARY	08-10-21	_
CONSTRUCTION	10-15-21	2

SHEET	
TITLE:	

CHECKED

BY:

PROJECT NOTES

-	Z	SHEET NUMBER:
·#dal		REVISION:
2770	2	N.

Ownership List

RECEIVED

DEC 21 2021

City of Pittsburg Community Development

PROPERTY TAX ID: 204-19-0-20-01-001.00-0

PROPERTY OWNER & ADDRESS:

City of Pittsburg

Subject Property: 910 Memorial Dr. Pittsburg, KS 66762

2041800002002000 2041800002003000 Hutz Ozark LLC 225 Bush St. STE 1800 San Francisco, CA 94104-4211

2041800002004000 Royce Parkview LLC 4742 N. 24th ST STE 325 Phoenix, AZ 85016-4884

2041804010008000 Lori L. McKinstry 324 W. 20th St. Pittsburg, KS 66762-2821

2041804010009000 Linda G. & Roger N. Martinson 268 W. 690th Ave. Farlington, KS 66734-4020

2041804010010000 Wenlyn Rentals LLC 609 W. Quincy St. Pittsburg, KS 66762-5691

2041901003002000 Mary E. Cashero 307 W. 20th St. Pittsburg, KS 66762-2820 2041901003003000 Kenneth R. & Linda A. Culbertson 29242 Imperial Rd. Carl Junction, MO 64834-6175

2041901003004000 Christina M. Oberle 614 W. Jefferson St. Pittsburg, KS 66762-4941

2041901003005000 2041901004002000 Roger P. & Heidi Jo Misasi 311 Winwood Dr. Pittsburg, KS 66762-5647

2041901003006000 Mark & Angela Johnson 1367 W. Hwy K Liberal, MO 64762-9512

2041901003007000 Russell L. Jones C/O Gary Conner Realty 108 W. 5th St. Pittsburg, KS 66762-3802

2041901004001000 CB Homes LLC 1010 N. Hwy 69 Frontenac, KS 66763-8100

2041901004003000 2041901004003010 2041901004004000 2041901009001000 2041901009003000 2041901009003010 Lightning Investments LLC 308 Memorial Dr. Pittsburg, KS 66762-3026 2041901014001010 2041904003002000 Young Men's Christian Association of Pittsburg, KS 1100 N. Miles St. Pittsburg, KS 66762-6901

2041901014001000 2041902001001000 2041903001001000 2041903002001000 2041904004001000 City of Pittsburg PO Box 688 Pittsburg, KS 66762-0688 We hereby certify the following to be a true and correct list of property owners within a 200 foot radius of:

The North half lying East of Highway 69, West of Olive Street, South of 20th Street, North of 12th Street and Northwest of Memorial Drive, all in Section 19, Township 30 South, Range 25 East of the 6th Principal and Meridian, Crawford County, Kansas, according to the United States Government Survey thereof.

Also that part of vacated 15th Street and vacated Olive Street lying adjacent to said tract.

And that part of Lots 6, 7 and 8 in Block 12, lying Northwest of Memorial Drive in the Kansas & Texas Coal Co's 4th Addition to Pittsburg, Crawford County, Kansas, according to the recorded Plat thereof.

RECEIVED

DEC 21 2021

City of Pittsburg Community Development

Security 1st Title LLC

Debra L. Engstrom, Licensed Abstractor

22-02: Variance - City or Pittsburg - 910 Memorial Drive

AFFIDAVIT OF PUBLICATION

STATE OF KANSAS, COUNTY OF CRAWFORD, SS:

Larry Hiatt, of lawful age, being first duly sworn, deposeth and saith, he/she is Legal Representative of the Pittsburg Morning Sun.

A daily newspaper published in the City of Pittsburg, Crawford County, Kansas, and not a trade, religious, or fraternal publication, and which newspaper has been entered as second-class mail matter in the United States The Pittsburg Post Office, Pittsburg, Kansas. been continuously Morning Sun has uninterruptedly published daily for than fifty weeks a year and has been so published for more than one year prior to the first publication of the notice hereinafter mentioned. A copy of that notice, is hereto attached, and was published in the regular and entire edition December 22, 2021 issue of said Pittsburg Morning Sun. Affiant further says that he has personal knowledge of the statements above set forth, and that they are true

Kelly Mitchell
Notary Public
State of Kansas
My Appt Exp

Notary Public

My Commission Expires:

Printer's Fee:

(Published in The Pittsburg Moming Sun on Thursday, December 22nd, 2021)

Public Notice

Date: December 21, 2021

Planning Commission/Board of Zoning Appeals
Notice of Public Hearing

The Planning Commission/Board of Zoning Appeals of the City of Pittsburg, KS, will hold a Public Hearing on January 24, 2022 at 5:30 pm, in the Municipal Court Room of the Law Enforcement Center, 201 N Pine, to consider a Petition for a Variance at 910 Memorial Drive. The property is described as: The North half lying East of Highway 69, West of Olive Street, South of 20th Street, North of 12th Street and Northwest of Memorial Drive, all in Section 19, Township 30 South, Range 25 East of the 6th Principal and Meridian, Crawford County, Kansas, according to the United States Government Survey thereof. Also that part of vacated 15th Street and vacated Olive Street lying adjacent to said tract. And that part of Lots 6, 7, and 8 in Block 12, lying Northwest of Memorial Drive in the Kansas & Texas Coal Co's 4th Addition to Pittsburg, Crawford County, Kansas, according to the recorded Plat thereof.

Dated this December 21, 2021.

Planning Commission/Board of Zoning Appeals
ATTEST:

Dexter Neisler

Zoning Administrator

Citizens with disabilities needing accommodations in order to attend this Public Hearing should contact the City Zoning Administrator's Office at 620-230-5517 no later than 48 hours prior to the scheduled public hearing.

RECEIVED

JAN 1 4 2022

City of Pittsburg Community Development

Tasks Report

22-02: Variance - City of Pittsburg - 910 Memorial Drive — City of Pittsburg

Generated: 20 Jan 2022 09:15



22-02: Variance - City of Pittsburg - 910 Memorial Drive - P&Z Administrative Tasks

Active Tasks

Upload Approved Minutes	Send Applicant Letter	Prepare City Commission Agenda Item	Task
			Start Date
			Due Date
DeAnna G.	DeAnna G.	DeAnna G.	Responsible Created
DeAnna G.	DeAnna G.	DeAnna G.	Created By
			Priority
0%	0%	0%	Progress Status
(Not started)	(Not started)	(Not started)	Status

Completed Tasks

Distribute Packets	Assigned Meeting Date	Notice to Utility Companies	Notice to Property Owners	Newspaper Publication	Completed Application Received	Task
						Start Date
						Due Date
DeAnna G.	Responsible					
DeAnna G.	Created By					
						Priority
100%	100%	100%	100%	100%	100%	Progress
Completed 01/20/2022 by DeAnna G.	Completed 12/22/2021 by DeAnna G.	Completed 12/22/2021 by DeAnna G.	Completed 12/22/2021 by DeAnna G.	Completed 12/21/2021 by DeAnna G.	Completed 12/21/2021 by DeAnna G.	Status

Generated for DeAnna Goering at 09:15 01/20/2022


VARIANCE APPLICATION TO THE DISTRICT ZONING REGULATIONS

BOARD OF ZONING APPEALS

FOR OFFICIAL USE ONLY

- Case No. 22-03
 Date Filed 12/7/2021
 Date Fee Paid 12/7/2021
- 4. Date of Hearing Valla (2)5. Date Published (2)

1. Applicant's Name Matthew W. + Ashley R. Sull-	
1. Applicant's Name 7 / / / SATE 9 / SATE	ran
2. Applicant's Address 1515 E. 14th P: HSburg KS Phon	
3. Address of Property Affected 15/5 E. 14th P. H. Sburg K.	5
4. Legal Description of Property The East(75) feet of	
in Block Number(4) in Belleplqine Secon	d Addition Filing
5. Applicant's Interest in the Property To build a Garage. L	ot Size 75' X 239'.
6. Nature of variance requested <u>Instead of 900 sznare</u> f	eet would Like
7. Attach a sketch of the proposed variance. 11/24/2021 (Date) (Signature of	Applicant)
	DECEIVED
(DO NOT WRITE IN THIS SPACE)	RECEIVED
(DO NOT WRITE IN THIS SPACE) BOARD OF ZONING APPEALS	DEC 07 2021
BOARD OF ZONING APPEALS	DEC 07 2021 City of Pittsburg

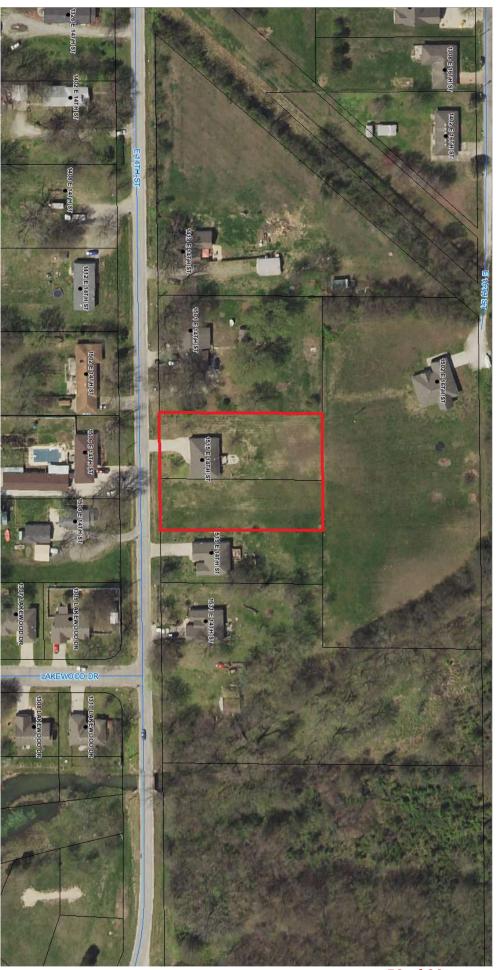

56 of 80

RECEIVED DEC 07 2021

City of Pittsburg Community Development



(THIS FORM MUST BE FILLED OUT TO ACCOMPANY ALL ARIANCE

APPLICATIONS MADE TO THE BOARD OF ZONING APPEALS AND ALL

REZONING AND CONDITIONAL USE APPLICATIONS MADE TO THE PLANNING Pittsburg

AND ZONING COMISSION and ALL CITYS)

Community Development

Prepared for: Gary Edwards

The following are the names and addresses of all persons owning property within 200 feet of the outside boundary of the property for which the request is being made:

Tract I: The West One Hundred (100) feet of Lot Number Ten (10) in Block Number Four (4) in Belleplaine Second Addition Filing, an addition to Pittsburg, Crawford County, Kansas, according to the recorded Plat thereof.

Tract II: The East Seventy Five (75) feet of Lot Number Ten (10) in Block Number Four (4) in Belleplaine Second Addition Filing, an addition to Pittsburg, Crawford County, Kansas, according to the recorded Plat thereof.

Gary R. & Lori L. Edwards	4057 Parkview Dr. Frontenac, KS 66763
Romesh & Jennifer Navaratnam	1531 E. 14 th St. Pittsburg, KS 66762
Bradley & Amanda Tune	1519 E. 14 th St. Pittsburg, KS 66762
Matthew W. Sullivan	1515 E. 14 th St. Pittsburg, KS 66762
Russell & Barbara Taylor	1502 E. 16 th St. Pittsburg, KS 66762
Eric Stockebrand	1419 E. 14 th St. Pittsburg, KS 66762
Daniel Hawn & Tina Lackamp	1501 E. 14 th St. Pittsburg, KS 66762
Tracy Noel & Lashawn Noel etal	1309 Lakewood Pittsburg, KS 66762
Trent Becker & William Holloway	1307 Lakewood Dr. Pittsburg, KS 66762
Leo Large St & Margaret L. Large	1003 W. 2 nd St. Pittsburg, KS 66762
Randall G & Gina R. Burke	1506 E. 14th St. Pittsburg, KS 66762
Kathryn M. Campbell	1502 E. 14th St. Pittsburg, KS 66762
Kyle & Denis Herron	1408 E. 14th St. Pittsburg, KS 66762

Done at Girard, Kansas this 21st day of October, 2021.

THE CRAWFORD COUNTY ABSTRACT COMPANY, INC.

David J. Saia, President

22-03: Variance-Sullivan 1515 E 14th

AFFIDAVIT OF PUBLICATION

STATE OF KANSAS, COUNTY OF CRAWFORD, SS:

Larry Hiatt, of lawful age, being first duly sworn, deposeth and saith, he/she is Legal Representative of the Pittsburg Morning Sun.

A daily newspaper published in the City of Pittsburg, Crawford County, Kansas, and not a trade, religious, or fraternal publication, and which newspaper has been entered as second-class mail matter in the United States Post Office, Pittsburg, Kansas. The Pittsburg Morning Sun been continuously and has uninterruptedly published daily for than fifty weeks a year and has been so published for more than one year prior to the first publication of the notice hereinafter mentioned. A copy of that notice, is hereto attached, and was published in the regular and entire edition December 23, 2021 issue of said Pittsburg Morning Sun. Affiant further says that he has personal knowledge of the statements above set forth, and that they are tru

December 23, 2021

Notary Public

My Commission Expires:

Printer's Fee:

Kelly Mitchell Notary Public State of Kansas My Appt Explo (Published in The Pittsburg Morning Sun on Thursday, December 23rd, 2021)

Public Notice

Date: December 20, 2021

Planning Commission/Board of Zoning Appeals

Notice of Public Hearing

The Planning Commission/Board of Zoning Appeals of the City of Pittsburg, KS, will hold a Public Hearing on January 24, 2022 at 5:30, in the Municipal Court Room of the Law Enforcement Center, 201 N Pine, to consider a Petition for a Variance at 1515 E 14th. The property is described as: The West One Hundred (100) feet of Lot Number Ten (10) in Block Number Four (4) in Belleplaine Second Addition Filing, an addition to Pittsburg, Crawford County, Kansas, according to the recorded Plat thereof. AND The East Seventy Five (75) feet of Lot Number Ten (10) in Block Number Four (4) in Belleplaine Second Addition Filing, an addition to Pittsburg, Crawford County, Kansas, according to the recorded Plat thereof. Dated this December 22, 2021.

Planning Commission/Board of Zoning Appeals

ATTEST:

Dexter Neisler

Zoning Administrator

Citizens with disabilities needing accommodations in order to attend this Public Hearing should contact the City Zoning Administrator's Office at 620-230-5517 no later than 48 hours prior to the scheduled public hearing.

RECEIVED

JAN 1 4 2022

City of Pittsburg Community Development

Tasks Report

22-03: Variance - Sullivan - 1515 E 14th — City of Pittsburg

Generated: 20 Jan 2022 09:17



22-03: Variance - Sullivan - 1515 E 14th - P&Z Administrative Tasks

Active Tasks

Upload Approved Minutes	Send Applicant Letter	Prepare City Commission Agenda Item	Task
			Start Date
			Due Date
DeAnna G.	DeAnna G.	DeAnna G.	Responsible Created
DeAnna G.	DeAnna G.	DeAnna G.	Created By
			Priority
0%	0%	0%	Progress Status
(Not started)	(Not started)	(Not started)	Status


Completed Tasks

Distribute Packets	Assigned Meeting Date	Notice to Utility Companies	Notice to Property Owners	Newspaper Publication	Completed Application Received	Task
						Start Date
						Due Date
DeAnna G.	Responsible					
DeAnna G.	Created By					
						Priority
100%	100%	100%	100%	100%	100%	Progress
Completed 01/20/2022 by DeAnna G.	Completed 12/20/2021 by DeAnna G.	Status				

Generated for DeAnna Goering at 09:17 01/20/2022

APPLICATION FOR CONDITIONAL USE PLANNING AND ZONING COMMISSION	1. Case No. 22-04 2. Date Filed 2/3/21 3. Date Fee Paid 4. Date of Hearing 1/24/22 5. Date Published 2/22/22
(TO BE COMPLET	ED BY THE APPLICANT)
1. Applicant's Name JOSE Maria	Ribera
2. Applicant's Address 912 E. 47	<u>Phone</u> 8164199928
3. Address of Property Affected 205 W	20th
4. Legal Description of Property	ng reasport-need
deed	
K3T coal co. 4th Addition, Blo	al 2, Lot 3
5. Applicant's Interest in the Property	The own J. 01051-0144
6. Zoning of Property R - 1 C	
7. Desired Use of Property Church	~~
8. Description of Plans Submitted (Plot Plan, Elev	rations, Etc.) Menovertime a
house los use	of a church.
9. I hereby certify that if the Conditional Use is	granted, I will complete construction in accordance with
plans submitted and approved by the Planning	and Zonling Continussion.
10/10/2021 (Date)	(Signature of Applicant)
(DO NOT WE	RITE IN THIS SPACE)
•	ZONING COMMISSION
Action by the Planning and Zoning Commission	. (Approve, Disapprove)
Restrictions Imposed:	
2. Nestrictions imposed.	

FOR OFFICIAL USE ONLY

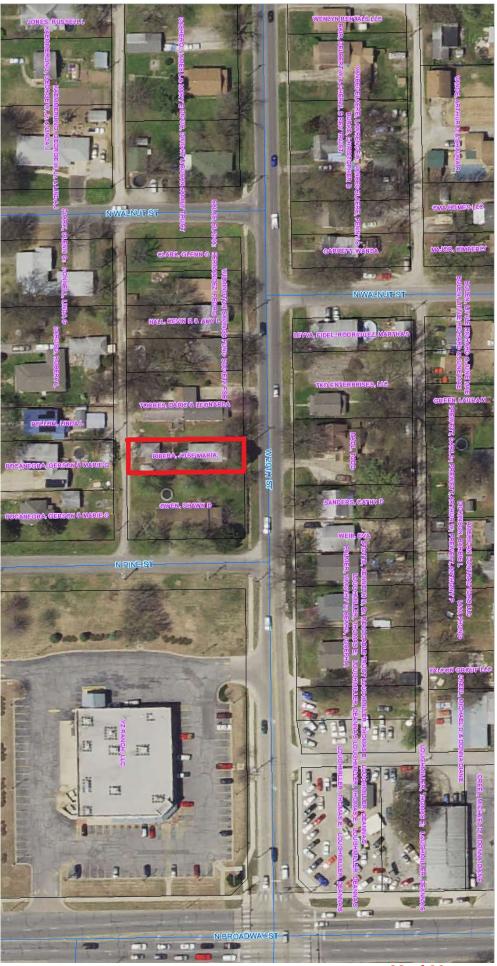

62 of 80

DEC 1 3 2021

(THIS FORM MUST BE FILLED OUT TO ACCOMPANY ALL ARIANCE APPLICATIONS MADE TO THE BOARD OF ZONING APPEALS AND ALL City of Pittsburg REZONING AND CONDITIONAL USE APPLICATIONS MADE TO THE PLANNING Development AND ZONING COMISSION and ALL CITYS)

Prepared for: Jose Maria Ribera

The following are the names and addresses of all persons owning property within 200 feet of the outside boundary of the property for which the request is being made:

Lot Number Three (3) in Block Number Two (2) in the Kansas and Texas Coal Company's 4th Addition to Pittsburg, Crawford County, Kansas, according to the recorded Plat thereof.

Leyva Fidel & Martha Rodriguez	126 W. 20th St. Pittsburg, KS 66762
TKO Enterprises, LLC	122 W. 20th St. Pittsburg, KS 66762
Todd J. Madl	120 W. 20th St. Pittsburg, KS 66762
Cathy D. Sanders	116 W. 20th St. Pittsburg, KS 66762
Eva Weir	610 E. 10 th St. Pittsburg, KS 66762
Kenneth Stotts Trust	316 Wickware Dr. Rm 24 Frontenac, KS 66763
Timothy Palmer & Joseph Beard	1802 Briar Dr. Webb City, MO 64870
Thomas & Deanna Loughmiller	511 Pearl St. Pittsburg, KS 66762
YZ Ranch LLC	P.O Box 1159 Deerfield, IL 60015
Shawn D. Owen	201 W. 20th St. Pittsburg, KS 66762
Dario & Leonarda Torres	207 W. 20th St. Pittsburg, KS 66762
Wilmington Savings Fund Society	1600 Douglas Rd Ste 200-A Anaheim CA 92806
Kevin & Amy Hall	862 S. 200 th Pittsburg, KS 66762
Salas Eladia & Pedro Hernandez	524 E. 21st St. Pittsburg, KS 66762
Glenn Clark	212 W. 19th St. Pittsburg, KS 66762
Robert Caruso	524 E. 25 th St. Pittsburg, KS 66762
Thomas & Linda Pollom	206 W. 19th St. Pittsburg, KS 66762
Gerson & Marie G Bocanegra	204 & 202 W. 19 th St. Pittsburg, KS 66762

Done at Girard, Kansas this 18th day of October, 2021.	
THE CRAWFORD COUNTY ABSTRACT COMPANY,	INC.
By David J. Saia, President	



200' Search



DISCLAIMER This is a product of the Crawford County GIS Department. The data displayed here has been developed with extensive cooperation from other county agencies, as well as other federal, statis and local government agencies. Crawford County disclaims responsibility for damages or inbillity that may arise from use of this may. This document does not constitute a legal survey. Any reside of this linformation is prohibited.



Please remit to: Crawford County Abstract Company, Inc. 106 W. Forest

Girard, KS 66743

Phone: (620) 724-6148 Fax (620) 724-6140

Pittsburg Customers: (620) 231-0870

Email Address: cca1@ckt.net

Billed to:

Jose Maria Ribera
205 W. 20th St.
Pittsburg, KS 66762
816-419-9928

David J. Jane

Date: 10/21/21

200 foot search
Properties (18)

22-04: conditional use Plemit Ribura- 205 W 20th

AFFIDAVIT OF PUBLICATION

STATE OF KANSAS, COUNTY OF CRAWFORD, SS:

Larry Hiatt, of lawful age, being first duly sworn, deposeth and saith, he/she is Legal Representative of the Pittsburg Morning Sun.

A daily newspaper published in the City of Pittsburg, Crawford County, Kansas, and not a trade, religious, or fraternal publication, and which newspaper has been entered as second-class mail matter in the United States Post Office, Pittsburg, Kansas. The Pittsburg Morning Sun has been continuously uninterruptedly published daily for than fifty weeks a year and has been so published for more than one year prior to the first publication of the notice hereinafter mentioned. A copy of that notice, is hereto attached, and was published in the regular and entire edition December 23, 2021 issue of said Pittsburg Morning Sun. Affiant further says that he has personal knowledge of the statements above set forth, and that they are true

December 23, 2021

Notary Public

My Commission Expires:

Printer's Fee:

Kelly Mitchell Notary Public State of Kansas My Appt Exp <u>[0]によっのう</u> (Published in The Pittsburg Morning Sun on Thursday, December 23rd, 2021)

Public Notice

Date: December 20, 2021

Planning Commission/Board of Zoning Appeals

Notice of Public Hearing

The Planning Commission/Board of Zoning Appeals of the City of Pittsburg, KS, will hold a Public Hearing on January 24, 2022 at 5:30 pm, in the Municipal Court Room of the Law Enforcement Center, 201 N Pine, to consider a Petition for a Conditional Use Permit under the provisions of Article 30 of the Pittsburg Zoning Ordinance to allow a church at 205 W 20th. The property is described as: Lot Number Three (3) in Block Number Two (2) in the Kansas and Texas Coal Company's 4th Addition to Pittsburg, Crawford County, Kansas, according to the recorded Plat thereof. Dated this December 22, 2021.

Planning Commission/Board of Zoning Appeals

ATTEST:

Dexter Neisler

Zoning Administrator

Citizens with disabilities needing accommodations in order to attend this Public Hearing should contact the City Zoning Administrator's Office at 620-230-5517 no later than 48 hours prior to the scheduled public hearing.

RECEIVED

JAN.14 2022

City of Pittsburg Community Development

Tasks Report

22-04: Conditional Use - Ribera - 205 W 20th — City of Pittsburg

Generated: 20 Jan 2022 09:18



22-04: Coniditional Use - Ribera - 205 W 20th - P&Z Administrative Tasks

Active Tasks

Upload Approved Minutes	Send Applicant Letter	Prepare City Commission Agenda Item	Task	
			Start Date	
			Due Date	
DeAnna G.	DeAnna G.	DeAnna G.	Responsible Created	
DeAnna G.	DeAnna G.	DeAnna G.	Created By	
			Priority	
0%	0%	0%	Progress Status	
(Not started)	(Not started)	(Not started)	Status	

Completed Tasks

Distribute Packets	Assigned Meeting Date	Notice to Utility Companies	Notice to Property Owners	Newspaper Publication	Completed Application Received	Task
						Start Date
						Due Date
DeAnna G.	Responsible					
DeAnna G.	Created By					
						Priority
100%	100%	100%	100%	100%	100%	Progress
Completed 01/20/2022 by DeAnna G.	Completed 12/20/2021 by DeAnna G.	Status				

Generated for DeAnna Goering at 09:18 01/20/2022

City of NOV 2.9 Return Completed Application to:

Zoning Administrator

Case No.: 21-25
Date Filed: 1/29/21
Date Paid: No Charge
Publication Date: No Publication
PC/BZA Date: 12/20/21

Site Plan Application

Applicant's Information		-				
Name: HORTON'S					1000	
Address: 509 EAC						
e/Phone: 620-249-3	3908	Email: k	rtone	spizzay	plus 66	76
Surveyor's Information		@	-live.	com	in the second	
Name: CORNERS	TONE.	REGIO	NAL	SURY	EYINGIL	-L
Address: III A V/	4th 4	t. PH	45BU	RGIK	5.6676	,1
Phone: 670-736-						
Architect's Information						OW
Name: STUART	0W4	LEY,	K5.*	2092	•	
Address: 106 BROO	KYIE	WRD.	PITTO	BUKL	1, KG 6676	2
11 Phone: 610-875-	9015	Email: 4	aarch	itecto	segol.c	.om
Engineer's Information					e e e Marie e e	
Name: 180						
Address:						
Phone:		Email:				
Property Information	1 2 2 2 2 2		3	1 3 1479.	2 lg + g	
Current Land Use of Property:	Current Zo	ning of Propert	y:			
➤ Commercial	☐ CP-0	☐ CP-1	CP-2	□CP-3	□ CP-4	
☐ Residential	□ RP-3	□ RP-4				
☐ Industrial	□ IP-1	☐ IP-2	☐ IP-3			
☐ Vacant	□ AP					
Proposed Use of Property:	6-4	TORE	BUIL	PING		
"REPLACEM	ENT	PR-5	ect"	2 50.34%		
Legal Description of Property:	41.1.	OFTRA	CTAI	n Cou	MYRYGIO	E
6th ADDITION to	the	140	FRIT	TOBUR	6. KS.	1075
Legal Description of Property: Legal Description of Property: LEGAL DESCRIPTION TO LEGAL DESCRIPTION TO	11114	7 KG	160	EAGT	Ath St (K.	-17
CHAITERY	OUNT	11,1	140		110	

NOV 29 2021

Site Plan Checklist

City of Pittsburg Community Development

In order to assure that proposed re-zonings to a "Planned" district and proposed uses requiring Conditional Use Permits meet the requirements of Article 23 of the Pittsburg Zoning Ordinance and will be compatible with surrounding properties and uses, it is hereby required that all applications for one of the "Planned" districts, or a Conditional Use Permit, except those uses exempted in Section 23-101 of the Pittsburg Zoning Ordinance, include a development plan, which must be approved as specified within Article 23 prior to any construction on the property. The development plan shall include and/or display the following information:

legal description, property boundary, existing utilities and easements, and natural and man-made features of the property. ■ A certified topographic survey at no more than a 2-foot contour drawn to the same scale as the property site map shall be provided when either the Zoning Administrator or the City Engineer determines that development will substantially increase the runoff coefficient, alter the			vn on an		Complies w/ Ordinance	
natural and man-made features of the property. • A certified topographic survey at no more than a 2-foot contour drawn to the same scale as the property site map shall be provided when either the Zoning Administrator or the City Engineer determines that development will substantially increase the runoff coefficient, alter the	Property site map drawn to a scale of 1"=20' or greater, indicating the					
A certified topographic survey at no more than a 2-foot contour drawn to the same scale as the property site map shall be provided when either the Zoning Administrator or the City Engineer determines that development will substantially increase the runoff coefficient, alter the		X Yes	☐ No	☐ Yes	☐ No	
to the same scale as the property site map shall be provided when either the Zoning Administrator or the City Engineer determines that development will substantially increase the runoff coefficient, alter the						
either the Zoning Administrator or the City Engineer determines that development will substantially increase the runoff coefficient, alter the						
development will substantially increase the runoff coefficient, alter the						
development will substantially increase the fundir coefficient, after the		XXX				
	development will substantially increase the runoff coefficient, alter the	MA Yes	□ No	☐ Yes	☐ No	
	direction of drainage flow from the property, or might obstruct traffic					
visibility.						
A development plan, drawn to the same scale as the property site map, indicating:	A development plan, drawn to the same scale as the property site map, indic	ating:				
Existing contours (shown as dashed lines) Yes □ No □ Yes □ No		X Yes	□ No	☐ Yes	□ No	
Proposed contours (shown as solid lines) ✓ Yes □ No □ Yes □ No		XYes	□ No	☐ Yes	□No	
Location and orientation of all existing and proposed buildings		X Yes	□ No	☐ Yes	□ No	
Area to be used for parking, including the number and arrangement of	 Area to be used for parking, including the number and arrangement of 	~				
stalls Yes No Yes No	stalls	X Yes	☐ No	☐ Yes	☐ No	
Areas to be developed for screening, including the location of plant	Areas to be developed for screening, including the location of plant	D 11				
materials, screening structures, and features	materials, screening structures, and features	☐ Yes	No No	☐ Yes	□ No	
Pedestrian and vehicular circulation and their relationship to existing	Pedestrian and vehicular circulation and their relationship to existing	¥				
streets, alleys, and public rights-of-way	streets, alleys, and public rights-of-way	Yes	□ No	☐ Yes	□ No	
Points of ingress and egress		X Yes	□ No	☐ Yes	□ No	
Location of all existing and proposed utilities (sanitary sewage	Estation of an existing and proposed utilities (sanitary sewage					
systems, water systems, storm drainage systems, gas lines, telephone Yes No Yes No	systems, water systems, storm drainage systems, gas lines, telephone	X Yes	☐ No	☐ Yes	□ No	
lines, and electric power lines	lines, and electric power lines					
■ Drainage controls (detention-retention ponds, weirs, pooling areas) No Yes > No Yes No	 Drainage controls (detention-retention ponds, weirs, pooling areas) 	☐ Yes	X No	☐ Yes	□ No	
Location, size, and characteristics of identification and business signs " Yes No Yes No	Location, size, and characteristics of identification and business signs •			☐ Yes		
Lighting layout, appurtenances, and intensity of illumination	Lighting layout, appurtenances, and intensity of illumination	☐ Yes	No	☐ Yes		
Finished floor elevations of all buildings and structures	 Finished floor elevations of all buildings and structures 	Yes	□ No			
Landscaping in a CP-0, CP-1, CP-2, or CP-3 zone, including: ✓ Yes □ No □ Yes □ No						
· Street yard planting Exist. To remain \ \(\Omega \subseteq \ \Omega \subseteq \ \No \subseteq \ \Yes \subseteq \ No	· Street yard planting Exist, to ramain 70					
· Landscape buffer \(\square\) \(\square\) Yes \(\square\) No \(\square\) Yes \(\square\) No	· Landscape buffer \\ \tag{16}			☐ Yes	□ No	
· Parking lot landscaping Yes No □ Yes □ No	· Parking lot landscaping		ĭNo	☐ Yes	□ No	



NOV 29 2021

Owner's Certification


City of Pittsburg Community Development


I/we acknowledge the receipt of the instruction packet explaining the method of submitting this application. I/we realize that this application cannot be processed unless it is completed in its entirety, is accompanied by all required supporting documentation as required in the instruction packet, and is accompanied by the appropriate, non-refundable fee.

I/we further certify that the foregoing information is true and correct to the best of my/our knowledge. If my/our request is granted, I/we will complete construction in accordance with plans submitted and approved by the Planning Commission/Board of Zoning Appeals (PC/BZA).

I/we authorize unannounced inspections of the subject property by City staff for the purpose of collecting information to review and analyze this request. I/we acknowledge that the PC/BZA and the Governing Body of the City of Pittsburg, Kansas, shall have authority to impose such conditions as it deems necessary in order to serve the public interest and welfare. This application must bear the signature(s) of the property owner(s). If an authorized agent signs on the owner's behalf, the agent shall sign his own name and attach the Owner Authorization form to this application. Office Use Only Date Received: \\\29/2\ Date Reviewed: 12/20/21 ☐ Approved ☐ Denied Conditions of Approval/Reasons for Denial Signature of Zoning Administrator (seal)


DEC 1 4 2021

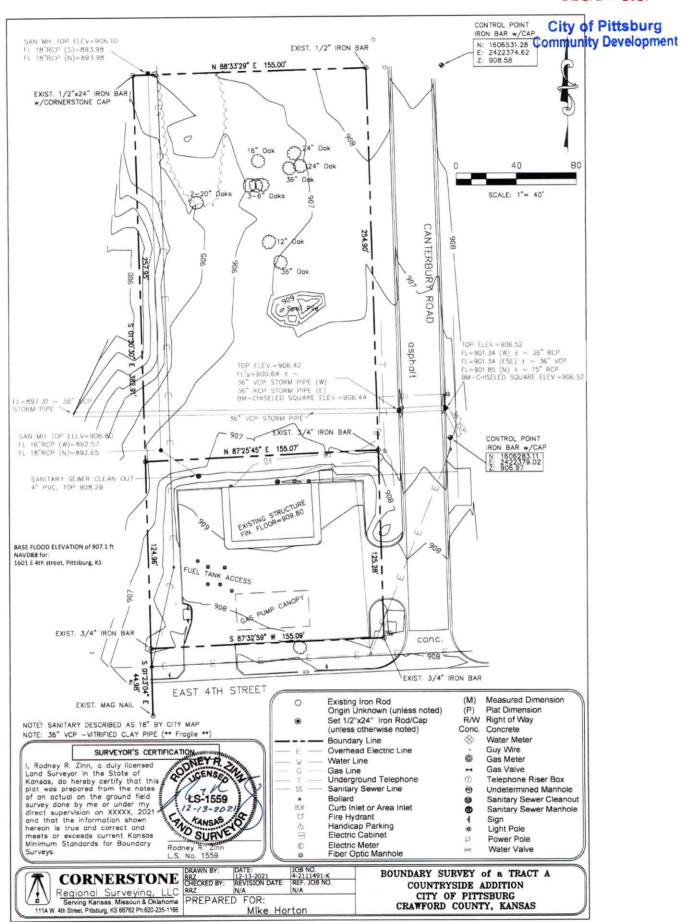

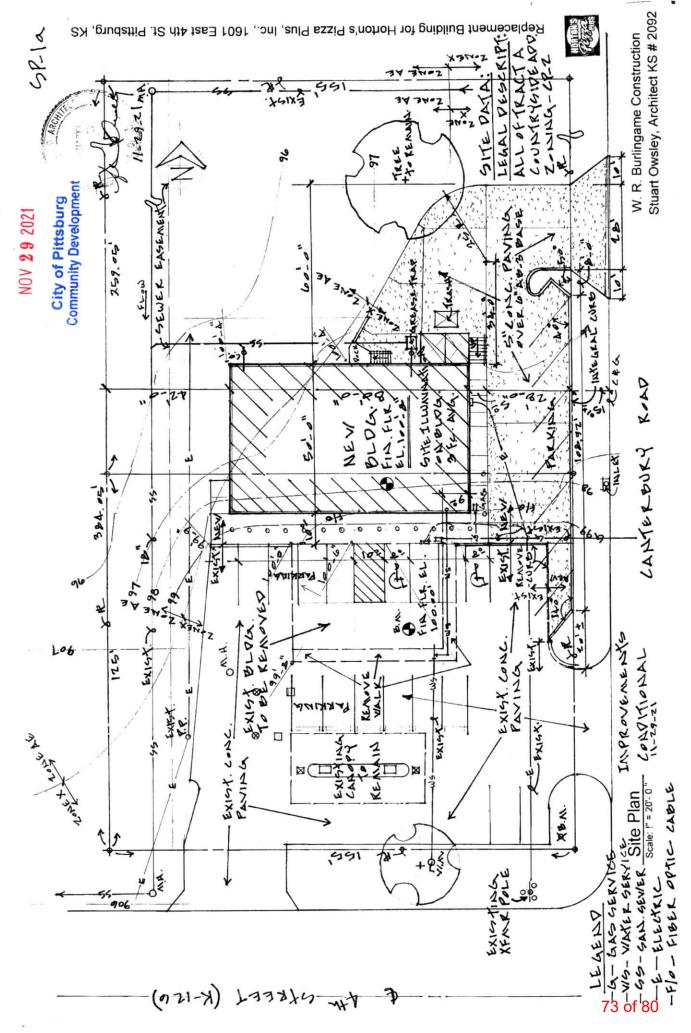

City of Pittsburg Community Development

COUNTRYSIDE 6TH ADDITION

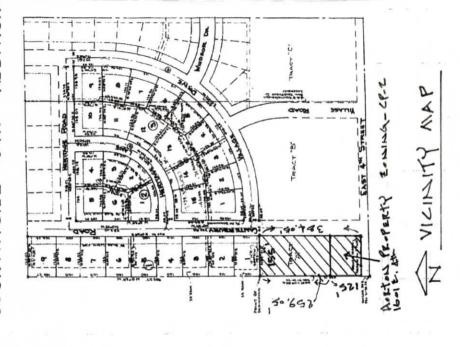



HORFIDE DE LA CONTRACTOR DE LA CONTRACTO

NEW BLDG, CONCEPTUAL

FLOOD ZONE MAP

Marine faces but a

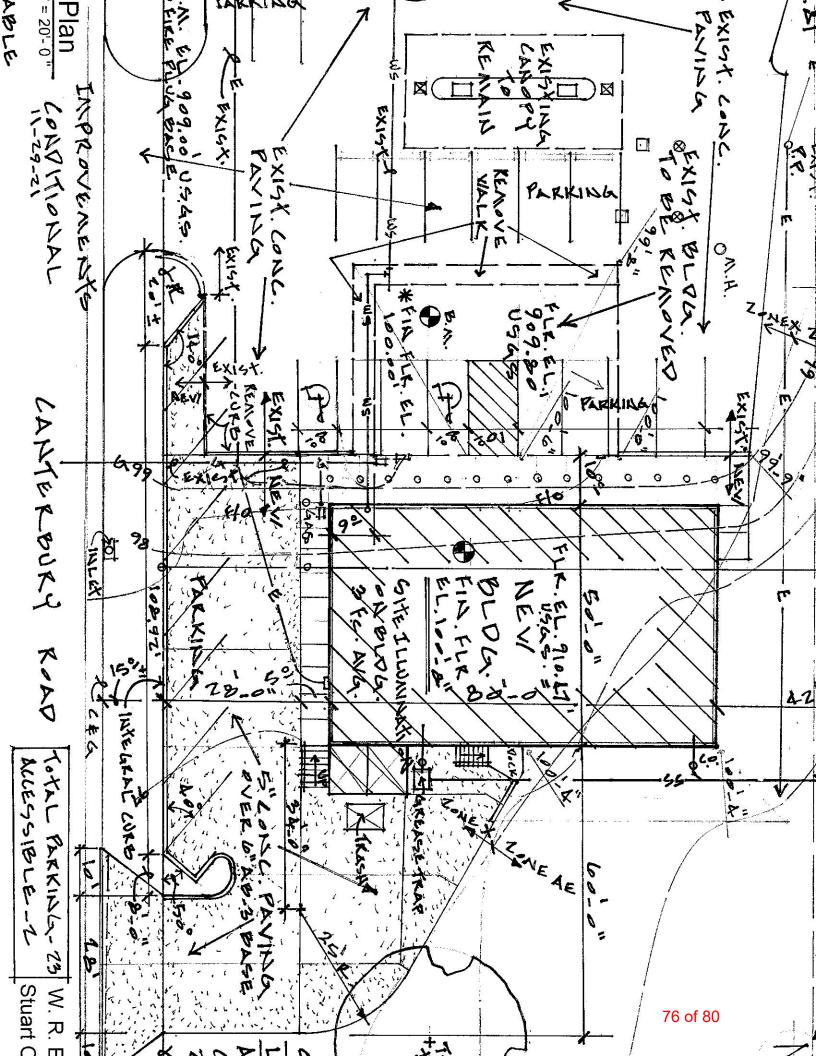

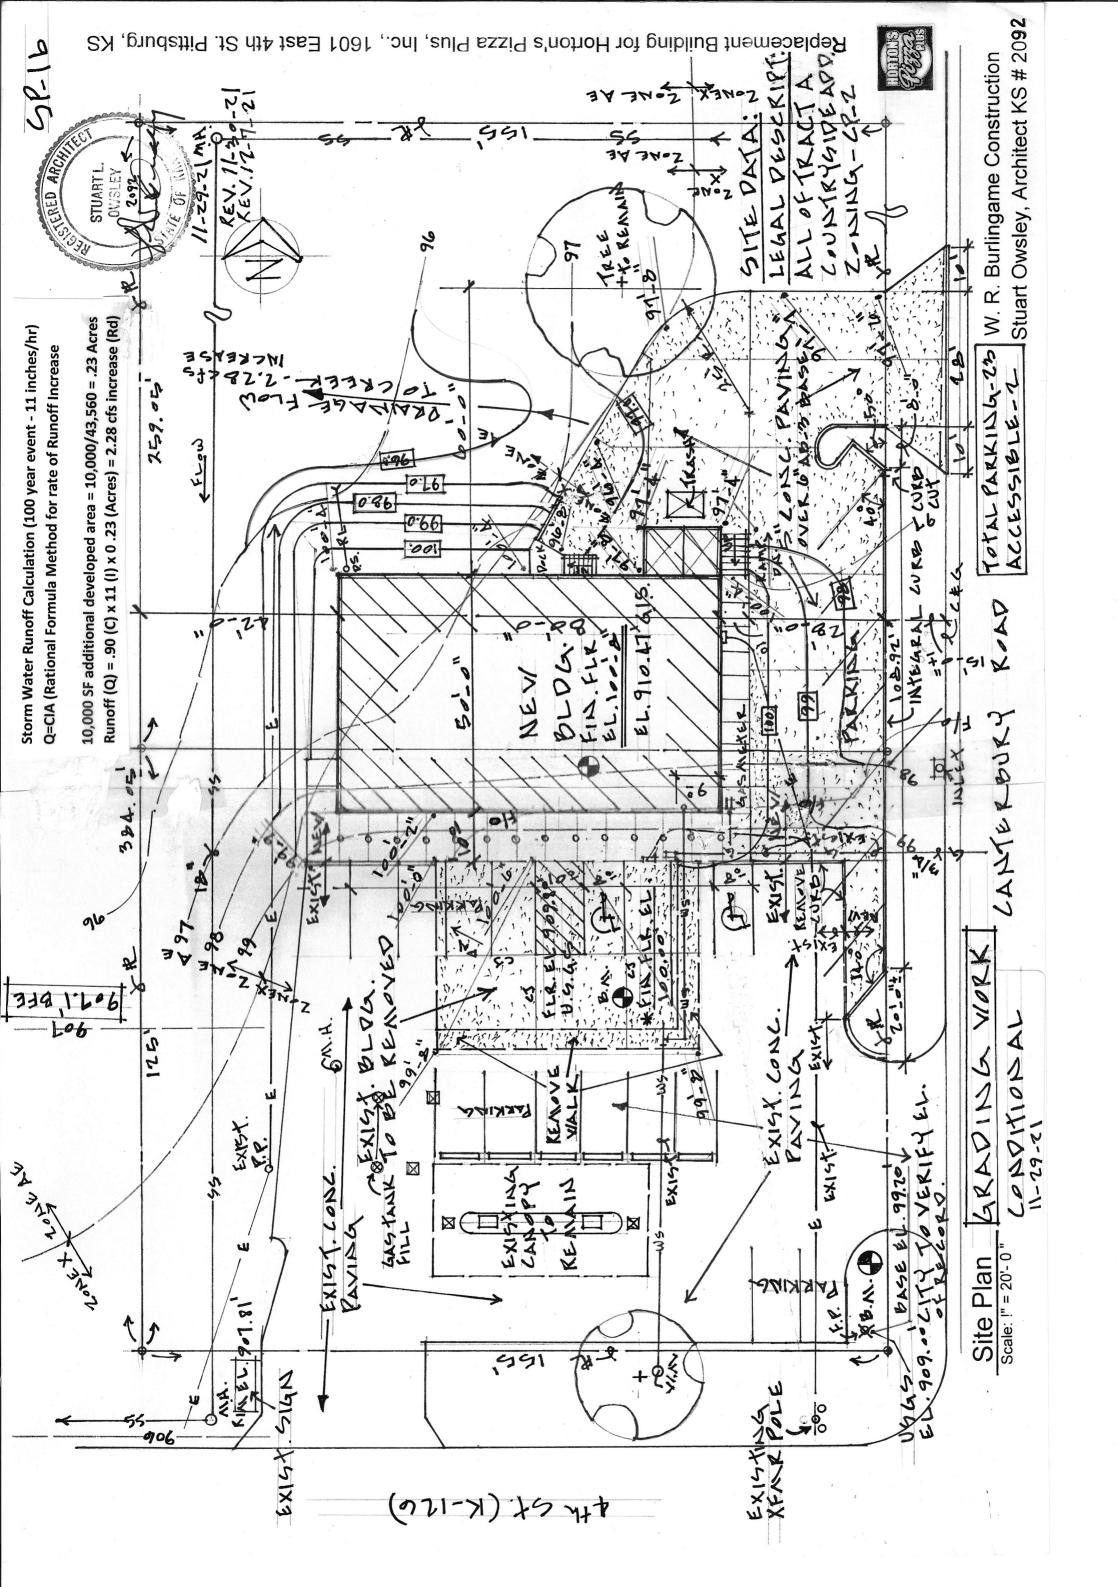

e-mail: soaarchitects@aol.com Cell: 620-875-9015

DIVISION 2 SITEWORK (Storm Sewer Piping for Horton's Pizza Plus Site)


All work shall comply with adopted City of Pittsburg storm water management requirements and ordinances.

- a) Storm sewer piping (STS) shall be 36 inch diameter x 20 foot long ADS Dual Wall N-12 high-density polyethylene (HDPE) solid pipe or ADS HP Storm Pipe sections with corrugated exterior and smooth interior, and plain end for gasketed bell and spigot joint design; or Reinforced Concrete Pipe (RCP) sections with grouted joints.
- b) Trench installed pipe sections with Class C granular embedment material both 4" below and 8" above pipe. Install pipe with uniform slope elevation at flow line as indicated on the drawings.
- c) HDPE Storm Sewer Piping system shall be installed complete with all pipe fittings, elbow bends, couplings and corrugated pipe adapters as required. Connection to existing manhole shall have grouted waterstop connection, flexible boot connection or pre-cast compression gasket connection with manhole adapter.
- d) Backfill trench with compacted native soil free of rocks, debris and vegetation.

Tasks Report

21-25: Site Plan - 1601 E 4th - Horton's Pizza — City of Pittsburg

Generated: 20 Jan 2022 09:20

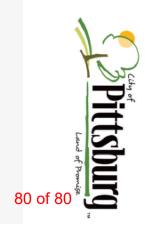

P&Z Administrative Tasks

Active Tasks

Upload Approved Minutes	Send Applicant Letter	Prepare City Commission Agenda Item	Task
			Start Date
			Due Date
DeAnna G.	DeAnna G.	DeAnna G.	Responsible Created
DeAnna G.	DeAnna G.	DeAnna G.	Created By
			Priority
0%	0%	0%	Progress Status
(Not started)	(Not started)	(Not started)	Status

Completed Tasks

Distribute Packets	Assigned Meeting Date	Completed Application Received	Task
			Start Date
			Due Date
DeAnna G.	DeAnna G.	DeAnna G.	Responsible Created By
DeAnna G.	DeAnna G.	DeAnna G.	Created By
			Priority
100%	100%	100%	Progress Status
Completed 01/20/2022 by DeAnna G.	Completed 01/04/2022 by DeAnna G.	100% Completed 12/01/2021 by DeAnna G.	Status

Generated for DeAnna Goering at 09:20 01/20/2022